DEVELOPMENT APPLICATION

Residential Flat Building

2 Mark St, 1-3 Marsden St, Lidcombe

DEVELOPMENT SUMMARY

SITE AREA 2 441 m2 (approx.)

FSR CALCULATION Permissible max. FSR = 5:1

PROPOSED FLOOR AREA **Ground Floor** 1,117.65 m2

> Level 1-3 1,234.28 m2 x 3 = 3,702.84 m2 1,207.27 m2 x 4 = 4,829.08 m2 Level 4-7

1,051.47 m2 Level 8 1,010.33 m2 Level 9

TOTAL PROPOSED AREA 11,711.37 m2 (FSR 4.8 : 1)

BUILDING HEIGHT Permissible

> = 33 m to the top of lift overun Proposed

BUILDING SETBACKS (ABOVE GROUND):

Corner setback (Mark St & Marsden St) - Southern and Western

0 m (to boundary) Eastern setback

Northern setback (Marsden Lane) Ground - Level 3 = 3m - 6m setback and 6.05m to the laneway centreline

> Level 4-7 = 6m setback and 9.05m to the laneway centreline Level 8-9 = 9m setback and 12.05m to the laneway centreline

BASEMENT SETBACKS: 6m setback at North Eastern corner (deep soil)

Min. No. of Parking

540.23 m2 COMMERCIAL AREAS

200 m2 (8.2%) DEEP SOIL AREA 400.57 m2 (16.41%) LANDSCAPED AREAS

COMMON OPEN SPACE 611.17 m2 (25%) at rooftop terrace

PARKING CALCULATION - (Auburn DCP 2010)

= 30 spaces (provided)

Drawing is NOT VALID or issued for use, unless checked

= 268 cages

Max. No. of Parking

1BR - 63 units	63 x 1 space	= 63 spaces	63 x 1 space	= 63 spaces
2BR - 74 units	74 x 1.2 spaces	= 89 spaces	74 x 3 spaces	= 222 spaces
3BR - 12 units	12 x 1.5 spaces	= 18 spaces	12 x 4 spaces	= 48 spaces
Visitor (101-250 units) Commercial	12 spaces (1 space/60m²)	= 9 spaces	55 spaces (4 spaces/40m²)	= 54 spaces

Minimum required car spaces based on Auburn DCP 2010:

170 residents parking

218 residents parking

9 commercial parking

Bicycle parking (min. 1 space/5 units)

13 visitor parking

Storage cages

12 visitor parking

No.of Bedrooms

9 commercial parking

PARKING CALCULATION (ADG & Guide to Traffic Generating Developments) - CBD Centres

 $0.4 \times 1BR = 0.4 \times 63 = 26 \text{ car spaces}$ $0.7 \times 2BR = 0.7 \times 74 = 52 \text{ car spaces}$ $1.2 \times 3BR = 1.2 \times 12 = 15 \text{ car spaces}$ = 22 visitor car spaces 149 units / 7

Developments:

- 22 visitor parking

Minimum required car spaces based on Guide to Traffic Generating

93 residents parking



Unit Mix / Yield

	1BR	2BR	3BR	Total
Ground	1 units (1AD)		3 units (1AD) 4 units	4 units
L1-3	30 units (6AD)	24 units		54 units
L4-7	32 units (4AD)	32 units		68 units
L8		10 units (1AD)	4 units	14 units
L9		8 units (2AD)	1 unit	9 units
Total	63 units (42.3%)	74 units (49.7%)	12 units (8%)	149 units (100%)

^{* 15} Adaptable-Livable Units provided (10%) & extra 15 Livable Units provided (10%)

NORTH:

Basix Building Fabric Requirements: 2 Mark St and 1-3 Marsden St

Element	Material Type	Detail
External walls	Hebel Powerpanel + R2.0 Insulation + PB	Dark colour
Internal walls	Plasterboard on studs	Intra-tenancy walls
	Hebel Powerpanel + R2.0 Insulation + PB	Inter-tenancy walls
Windows	ALM-002-01 A Aluminium B SG Clear	NFRC Glazing System values: ⇒ U ≤ 6.70 and SHGC = 0.70 (± 10%)
	Aluminium B SG High Solar Gain Low-E	NFRC Glazing System values: ⇒ U ≤ 5.40 and SHGC = 0.58 (± 10%)
		Modifying units: 1.01, 1.14, 2.01, 2.14, 3.01, 3.14, 8.04, 8.05, 8.12, 8.13, 8.14
Skylights	Single Glazed Clear	
Downlights	Deafuilt as BASIX protocol	Sealed option
Floor	Concrete slab	Tile (kitchen & wet)
		Laminated Timber (bedrooms and living)
	Concrete slab + R1.0 Insulation (Below car park and outside air)	To basement, outside air, carpark
Ceiling +	Concrete	
Roof	Concrete +R3.0 Insulation (top level)	Light colour

or as noted

Drawing Schedule

- Street Views (Existing & Future Context)
- Site Analysis 02
- Basement 4 Plan
- Basement 3 Plan Basement 2 Plan
- Basement 1 Plan
- Site Plan
- Ground FI Plan_OPTION 1
- Level 1-3 Plan (Typical) OPTION 1
- Level 1-3 Plan (Typical)_OPTION 1
- Level 4-7 Plans (Typical)_OPTION 1 Level 8 Plan_OPTION 1
- Level 9 Plan_OPTION 1
- Roof Plan_OPTION 1
- Top Roof Plan South Elevation OPTION 1
- North Elevation Marsden St_OPTION 1
- West Elevation Mark St_OPTION 1
- East Elevation

- Shadow Diagrams (Existing Context)
- Shadow Diagrams (Winter Solstice) 09AM-12PM
- Shadow Diagrams (Winter Solstice) 1PM-3PM
- Current Solar Access to Existing 10-14 Marsden St
- Shadow Impact to 10-14 Marsden St (Winter Solstice) Indicative Future Context of 10-14 Marden St
- Shadow Impact to 10-14 Marsden St (FUTURE CONTEXT)
- Shadow Impact to 4-14 Mark St (Winter Solstice)
- Shadow Impact to 4-14 Mark St (Winter Solstice)_OPTION 1
- East-Facing Units_4-14 Mark St
- **FUTURE CONTEXT**
- Shadow Diagram Future Context (Winter Solstice)
- Shadow Diagram Future Context (Winter Solstice)
- Shadow Diagram Future Context (Equinox)
- Shadow Diagram Future Context (Equinox) Shadow Impact to 4-14 Mark St during Equinox (9-11AM)
- Shadow Diagram Future Context (Summer Solstice)
- Shadow Diagram Future Context (Summer Solstice)
- **GFA Calculation**
- Solar & Cross Ventilation Diagrams 01

In reference to two parking controls comparison above, the provided car spaces =

Development Application

Original Design:
Zhinar Architects



GENERAL NOTES: Figured dimensions shall be taken in preference to scaling. Drawing to be read in conjunction with information on first page. Check all dimensions and levels on site before commencing work or ordering materials.

All existing ground lines & trees location are approximate, therefore to be verified on-site by the builder. Any discrepancies to be verified back to Zhinar Architects before proceeding. All workmanship and materials shall comply with all relevant codes, ordinances, Australian Standards and manufacturer's instructions.

Unless noted 'Issued for Construction', drawing not to be used for construction. COPYRIGHT: INFORMATION ON THIS DRAWING IS THE COPYRIGHT OF ZHINAR ARCHITECTS. COPYING OR USING THIS DRAWING IN WHOLE OR PART WITHOUT WRITTEN PERMISSION INFRINGES COPYRIGHT.

Cover Sheet DESIGNED: DRAWN: COMMENCED: SCALE: 1:100@A1 A3 SHEET 1:200@A3 May 2017 AHM ΥT


L.G.A: Cumberland Council



Residential Flat Building 2 Mark St, 1-3 Marsden St

Lidcombe, NSW 2141 8539 DA - E:01

DRAWINGS AMENDED AS PER JRPP COMMENTS 30/10/2018 DRAWINGS AMENDED AS PER COUNCIL RFI - MAY '18. AMENDMENTS SHOWN CLOUDED. AHM 23/05/2018 DA-B DRAWINGS AMENDED. ISSUED FOR COUNCIL REVIEW. AHM 13/04/2018 DA-A ISSUED FOR DEVELOPMENT APPLICATION 21/11/2017 AHM ΥT

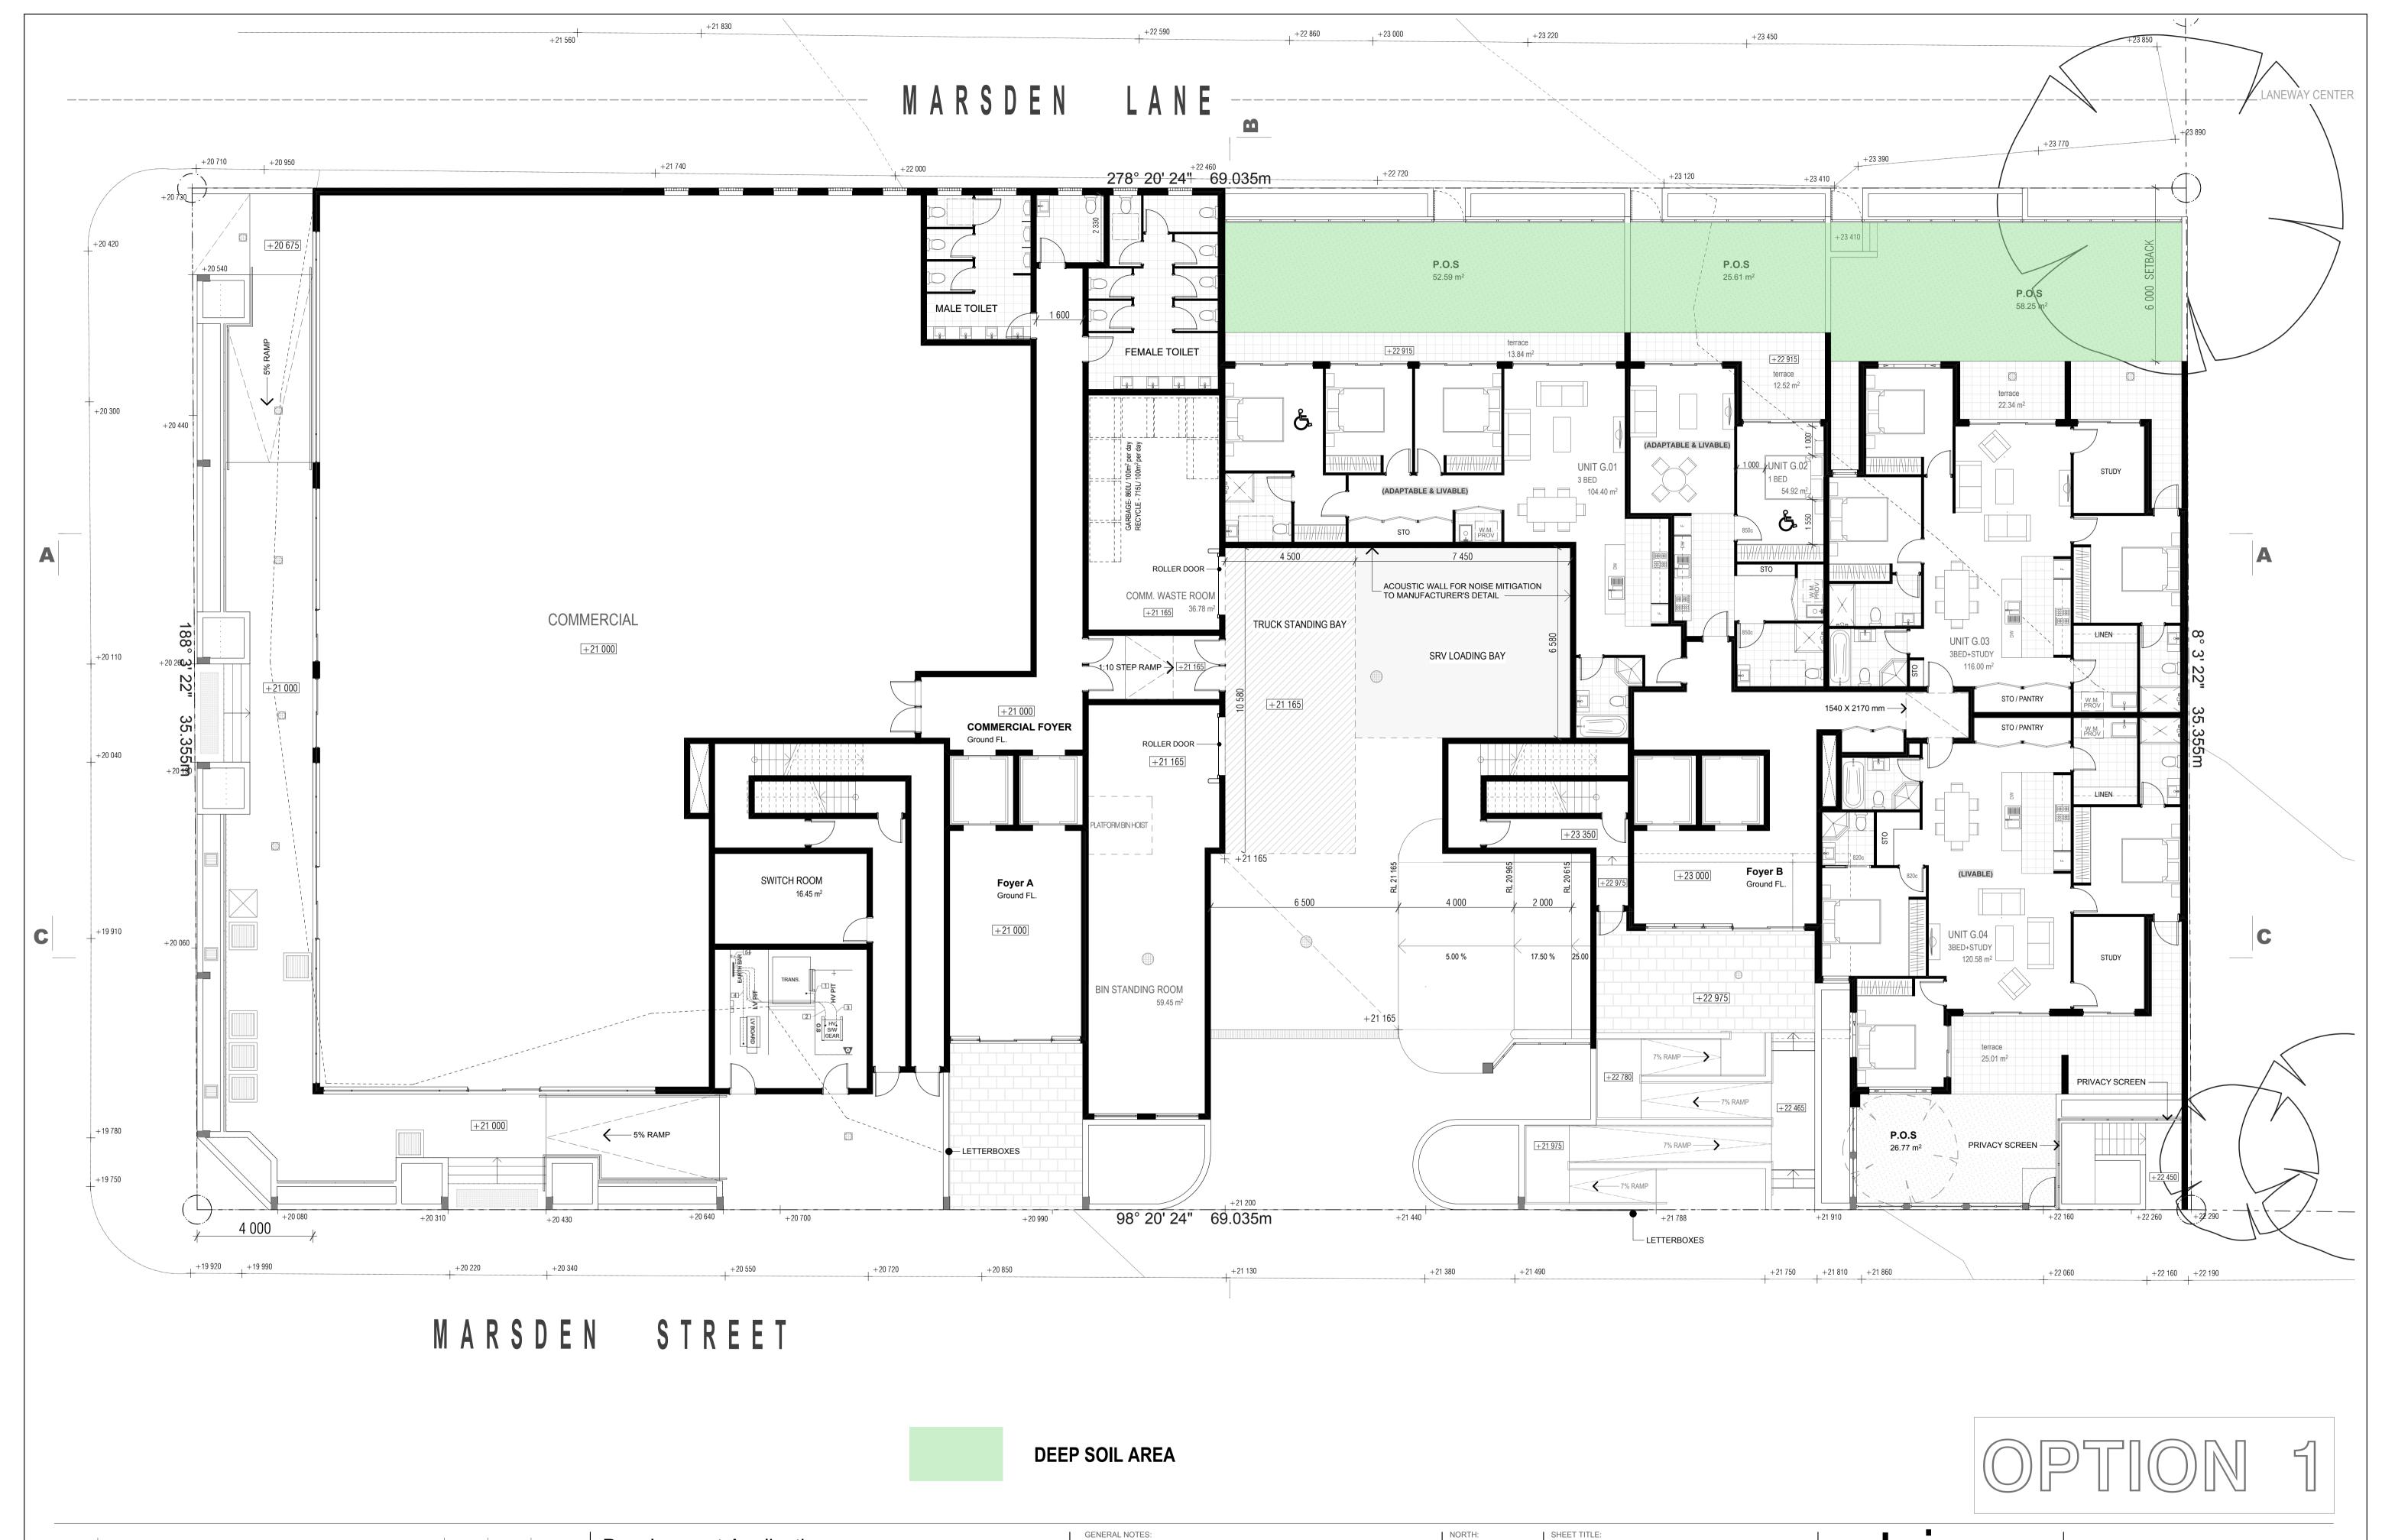

DA-E DRAWINGS AMENDED AS PER JRPP COMMENTS.

DA-C DRAWINGS AMENDED AS PER COUNCIL RFI - MAY '18. AMENDMENTS SHOWN CLOUDED.

DA-B DRAWINGS AMENDED. ISSUED FOR COUNCIL REVIEW.

DA-A ISSUED FOR DEVELOPMENT APPLICATION

21/11/2017 YT AHM

Drawing is NOT VALID or issued for use, unless checked.

Development Application

Original Design:
Zhinar Architects

DIAL BEFORE YOU DIG

Figured dimensions shall be taken in preference to scaling.

Drawing to be read in conjunction with information on first page.

Check all dimensions and levels on site before commencing work or ordering materials.

All existing ground lines & trees location are approximate, therefore to be verified on-site by the builder.


Any discrepancies to be verified back to Zhinar Architects before proceeding.

All workmanship and materials shall comply with all relevant codes, ordinances, Australian Standards and

All workmanship and materials shall comply with all relevant codes, ordinances, Australian Standards a manufacturer's instructions.

Unless noted 'Issued for Construction', drawing not to be used for construction.

COPYRIGHT: INFORMATION ON THIS DRAWING IS THE COPYRIGHT OF ZHINAR ARCHITECTS. COPYING OR USING THIS DRAWING

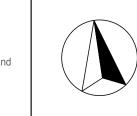

Ground FI Plan_OPTION 1

DESIGNED: DRAWN: COMMENCED: SCALE

DESIGNED: DRAWN: COMMENCED: SCALE: PRINT:


AHM Y T May 2017 1:100@A1 A3 SHEET
1:200@A3
or as noted

PLOT:
L.G.A: Cumberland Council Tuesday, 30 October 2018 5:07 PM



Suite 1 Level 2, 2 Rowe Street (Cnr Ryedale Road), Eastwood NSW 2122 PH: (+61 2) 8893 8888 WEB: www.zhinar.com.au Residential Flat Building
2 Mark St, 1-3 Marsden St
Lidcombe, NSW 2141

JOB No.: 8539 DA - E:10

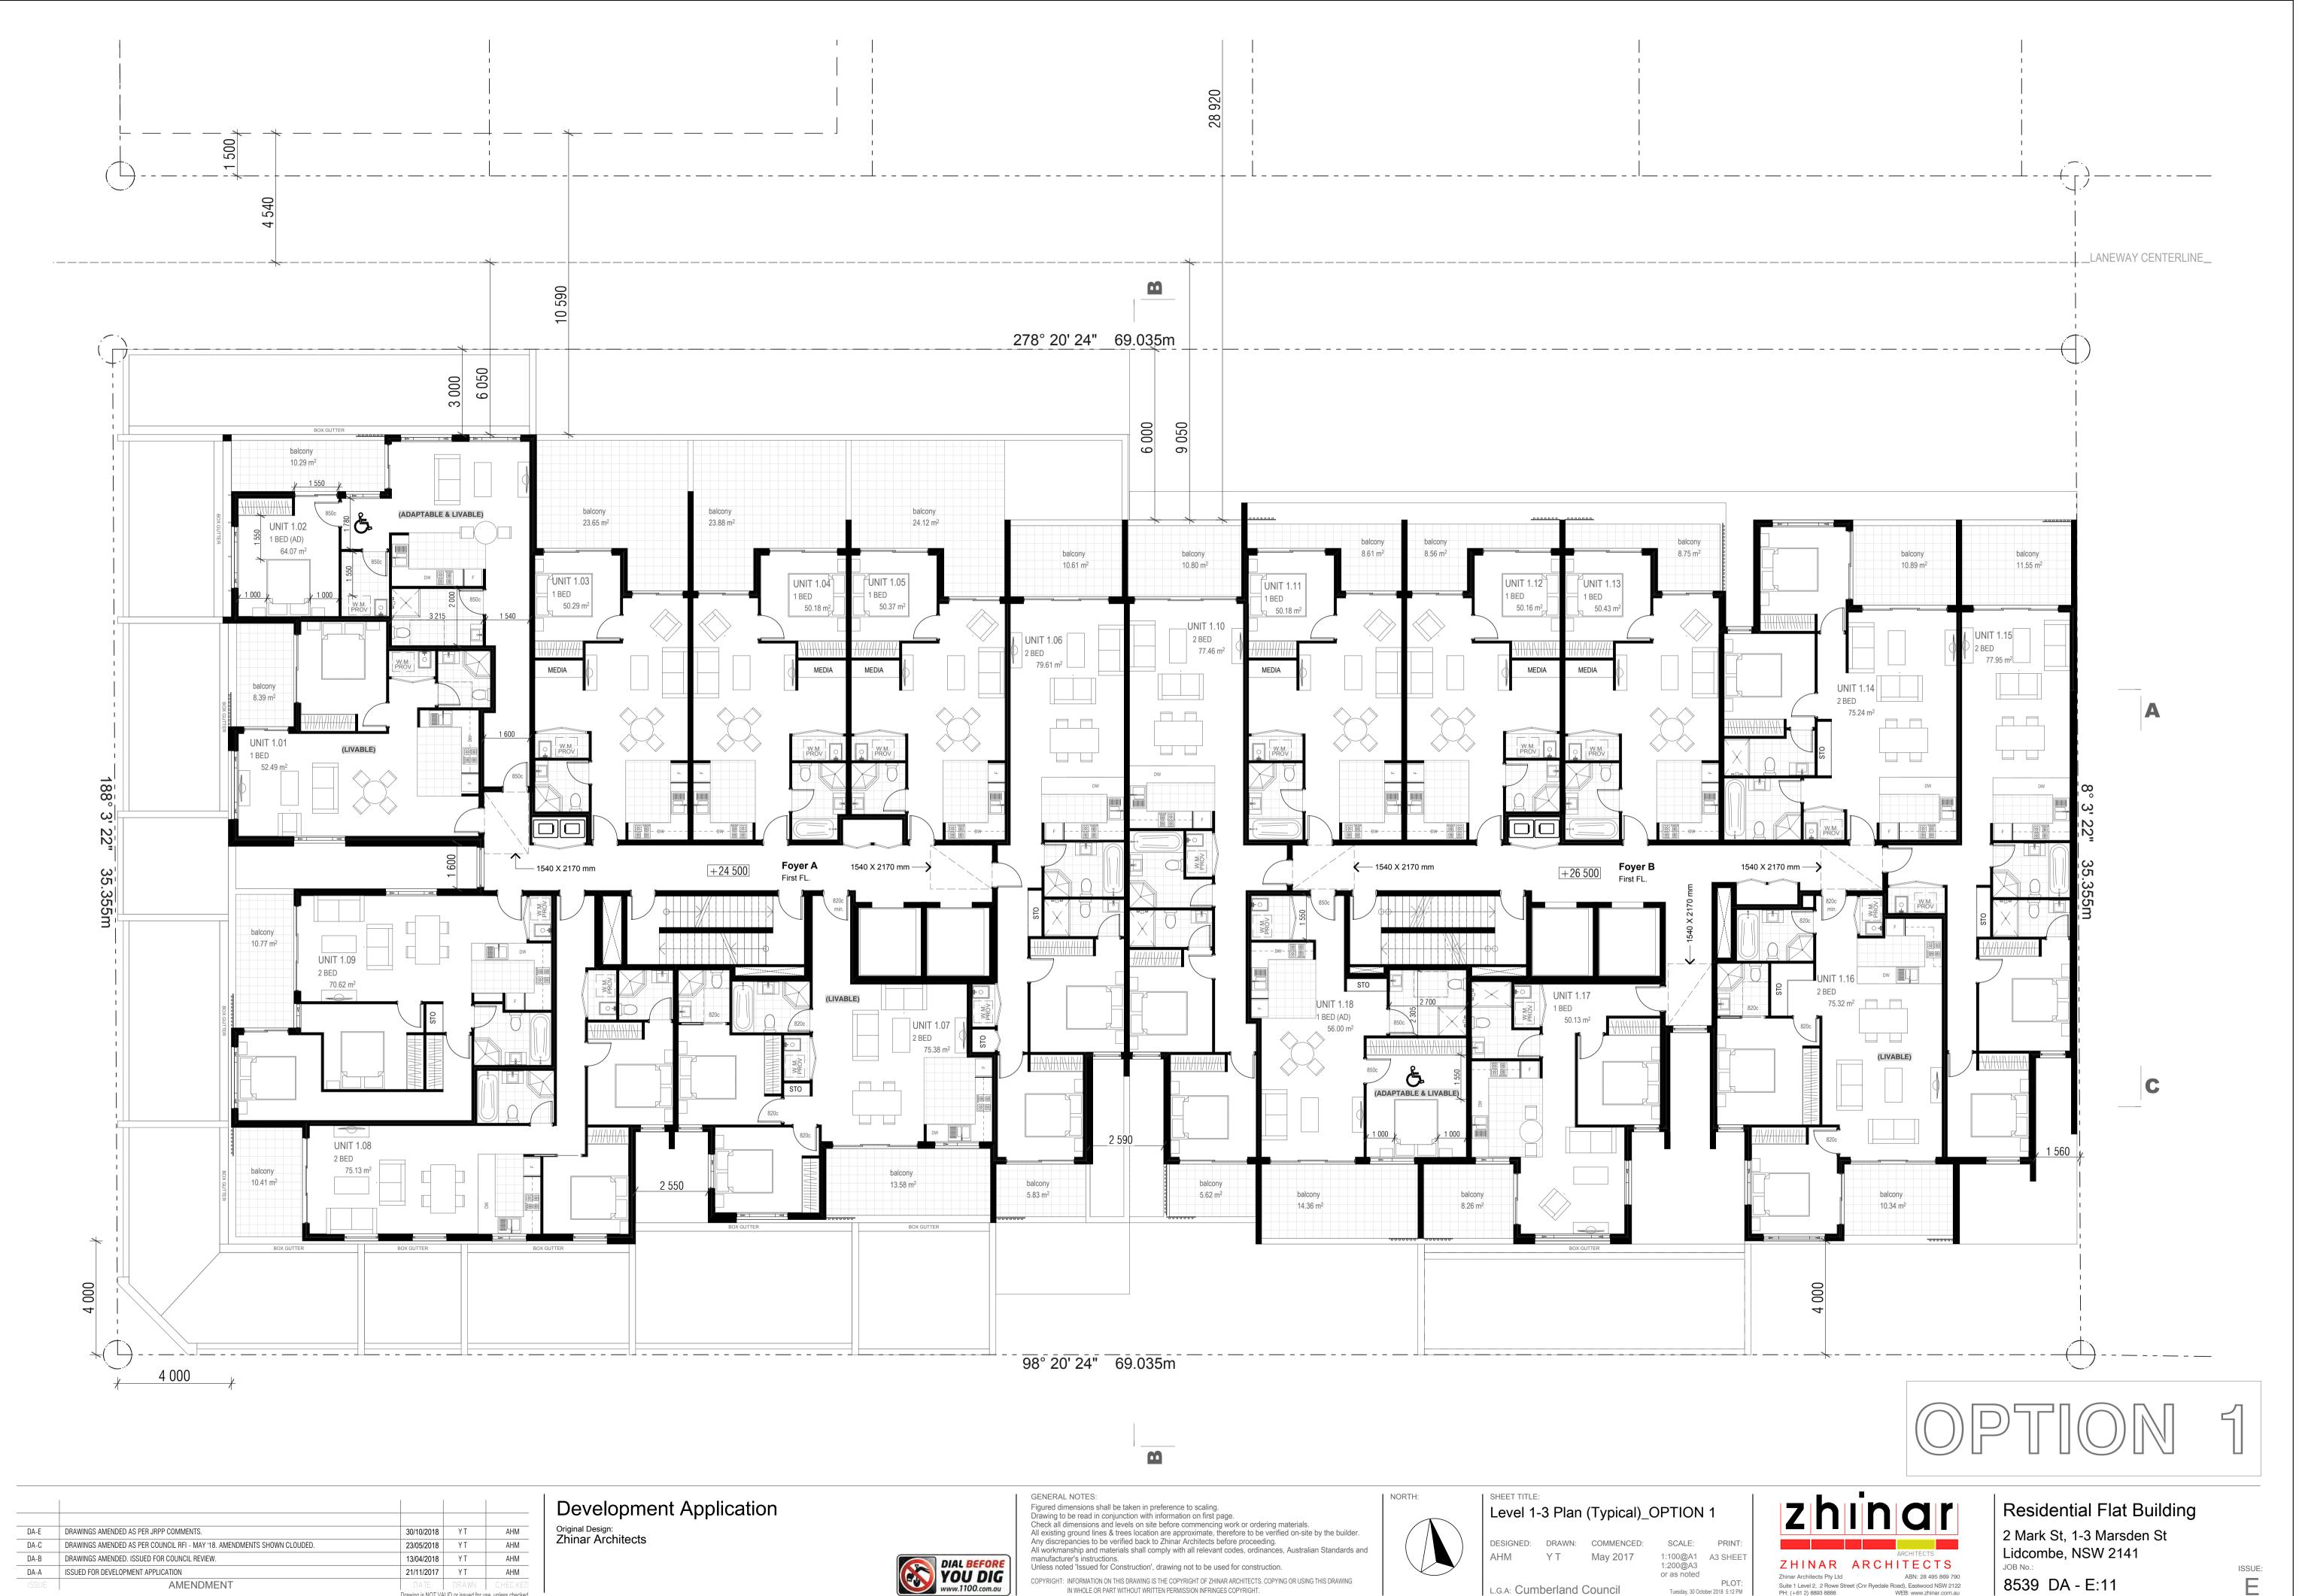

COPYRIGHT: INFORMATION ON THIS DRAWING IS THE COPYRIGHT OF ZHINAR ARCHITECTS. COPYING OR USING THIS DRAWING

DA-A ISSUED FOR DEVELOPMENT APPLICATION

Drawing is NOT VALID or issued for use, unless checked.

ISSUE:


8539 DA - E:11

Zhinar Architects Pty Ltd

Tuesday, 30 October 2018 5:12 PM

L.G.A: Cumberland Council

Suite 1 Level 2, 2 Rowe Street (Cnr Ryedale Road), Eastwood NSW 2122 PH: (+61 2) 8893 8888 WEB: www.zhinar.com.au

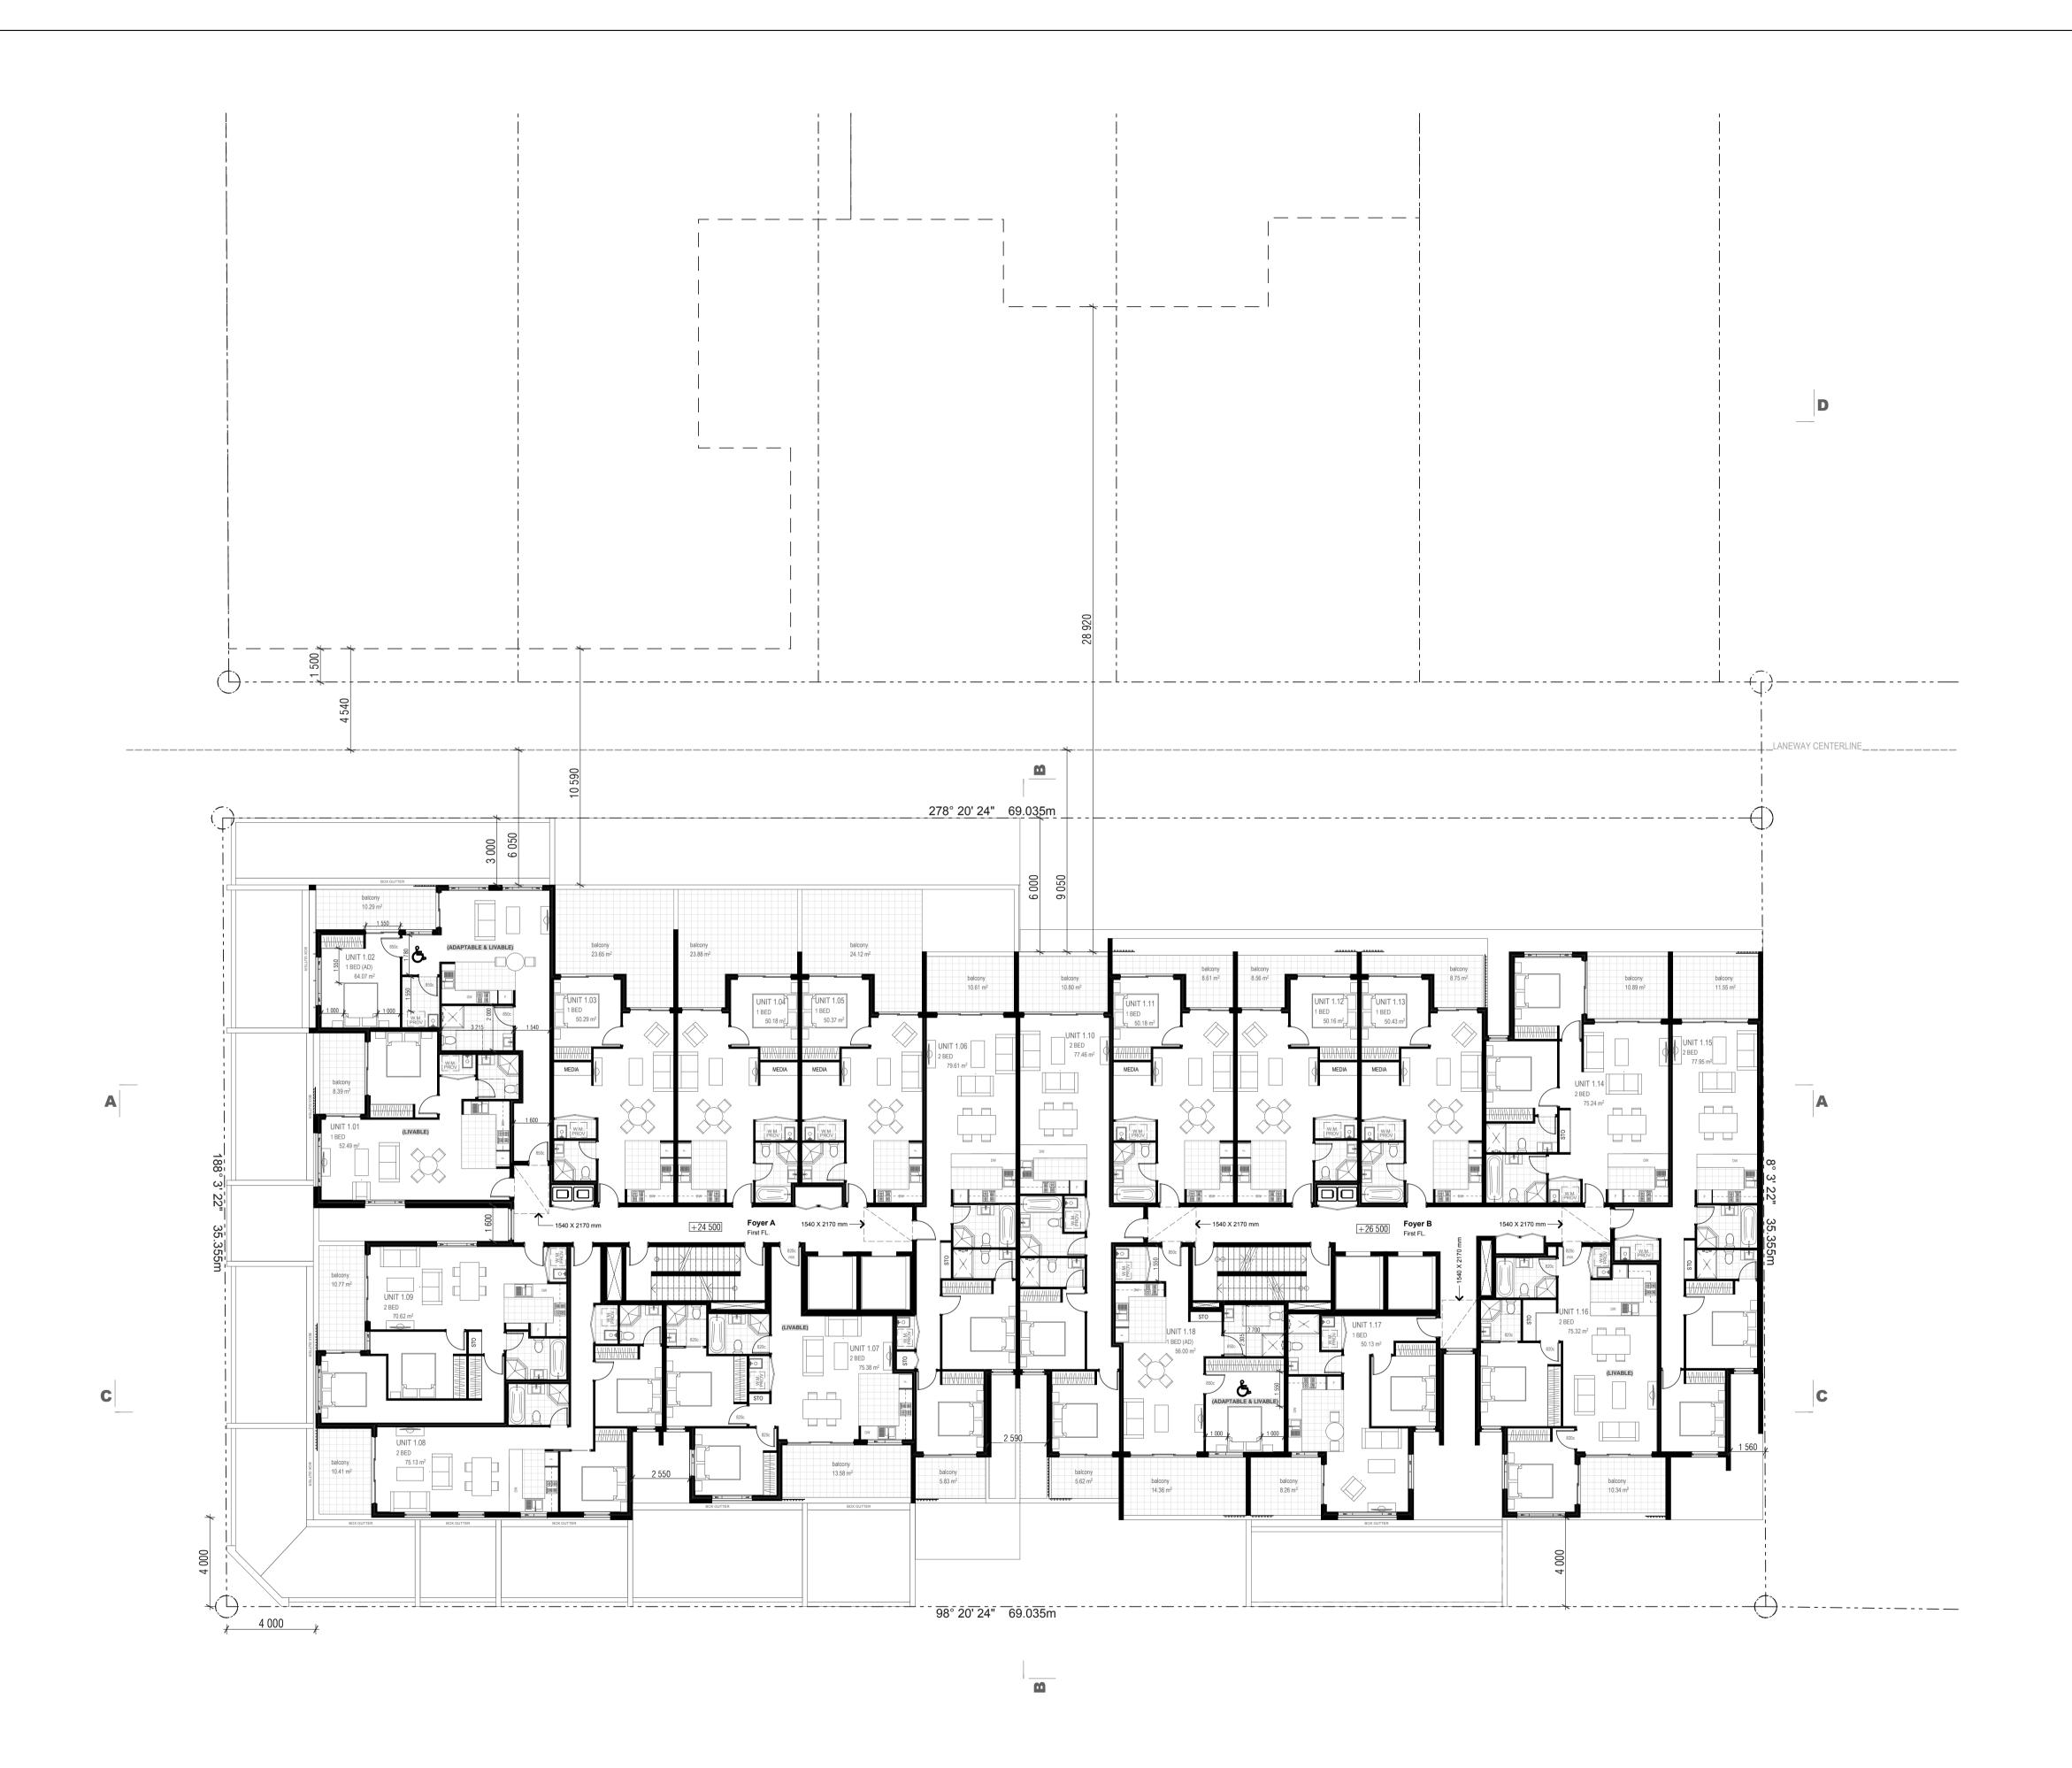

OPTION =

DA-E	DRAWINGS AMENDED AS PER JRPP COMMENTS.	30/10/2018	ΥT	AHM
DA-C	DRAWINGS AMENDED AS PER COUNCIL RFI - MAY '18. AMENDMENTS SHOWN CLOUDED.	23/05/2018	ΥT	AHM
DA-B	DRAWINGS AMENDED. ISSUED FOR COUNCIL REVIEW.	13/04/2018	ΥT	AHM
DA-A	ISSUED FOR DEVELOPMENT APPLICATION	21/11/2017	ΥT	AHM
ISSUE	AMENDMENT	DATE	DRAWN	CHECKED
		Drawing is NOT VA	LID or issued for us	se, unless checked.

Development Application

Original Design:
Zhinar Architects



GENERAL NOTES:
Figured dimensions shall be taken in preference to scaling.
Drawing to be read in conjunction with information on first page.
Check all dimensions and levels on site before commencing work or ordering materials.
All existing ground lines & trees location are approximate, therefore to be verified on-site by the builder.
Any discrepancies to be verified back to Zhinar Architects before proceeding.
All workmanship and materials shall comply with all relevant codes, ordinances, Australian Standards and manufacturer's instructions.

Unless noted 'Issued for Construction', drawing not to be used for construction.

COPYRIGHT: INFORMATION ON THIS DRAWING IS THE COPYRIGHT OF ZHINAR ARCHITECTS. COPYING OR USING THIS DRAWING IN WHOLE OR PART WITHOUT WRITTEN PERMISSION INFRINGES COPYRIGHT.

SHEET TITLE:

Level 1-3 Plan (Typical)_OPTION 1

L.G.A: Cumberland Council

NORTH:

DESIGNED: DRAWN: COMMENCED: SCALE: PRINT:


AHM YT May 2017 1:100@A1 A3 SHEET 1:200@A3 or as noted


Tuesday, 30 October 2018 5:12 PM





Residential Flat Building
2 Mark St, 1-3 Marsden St
Lidcombe, NSW 2141

8539 DA - E:11.1

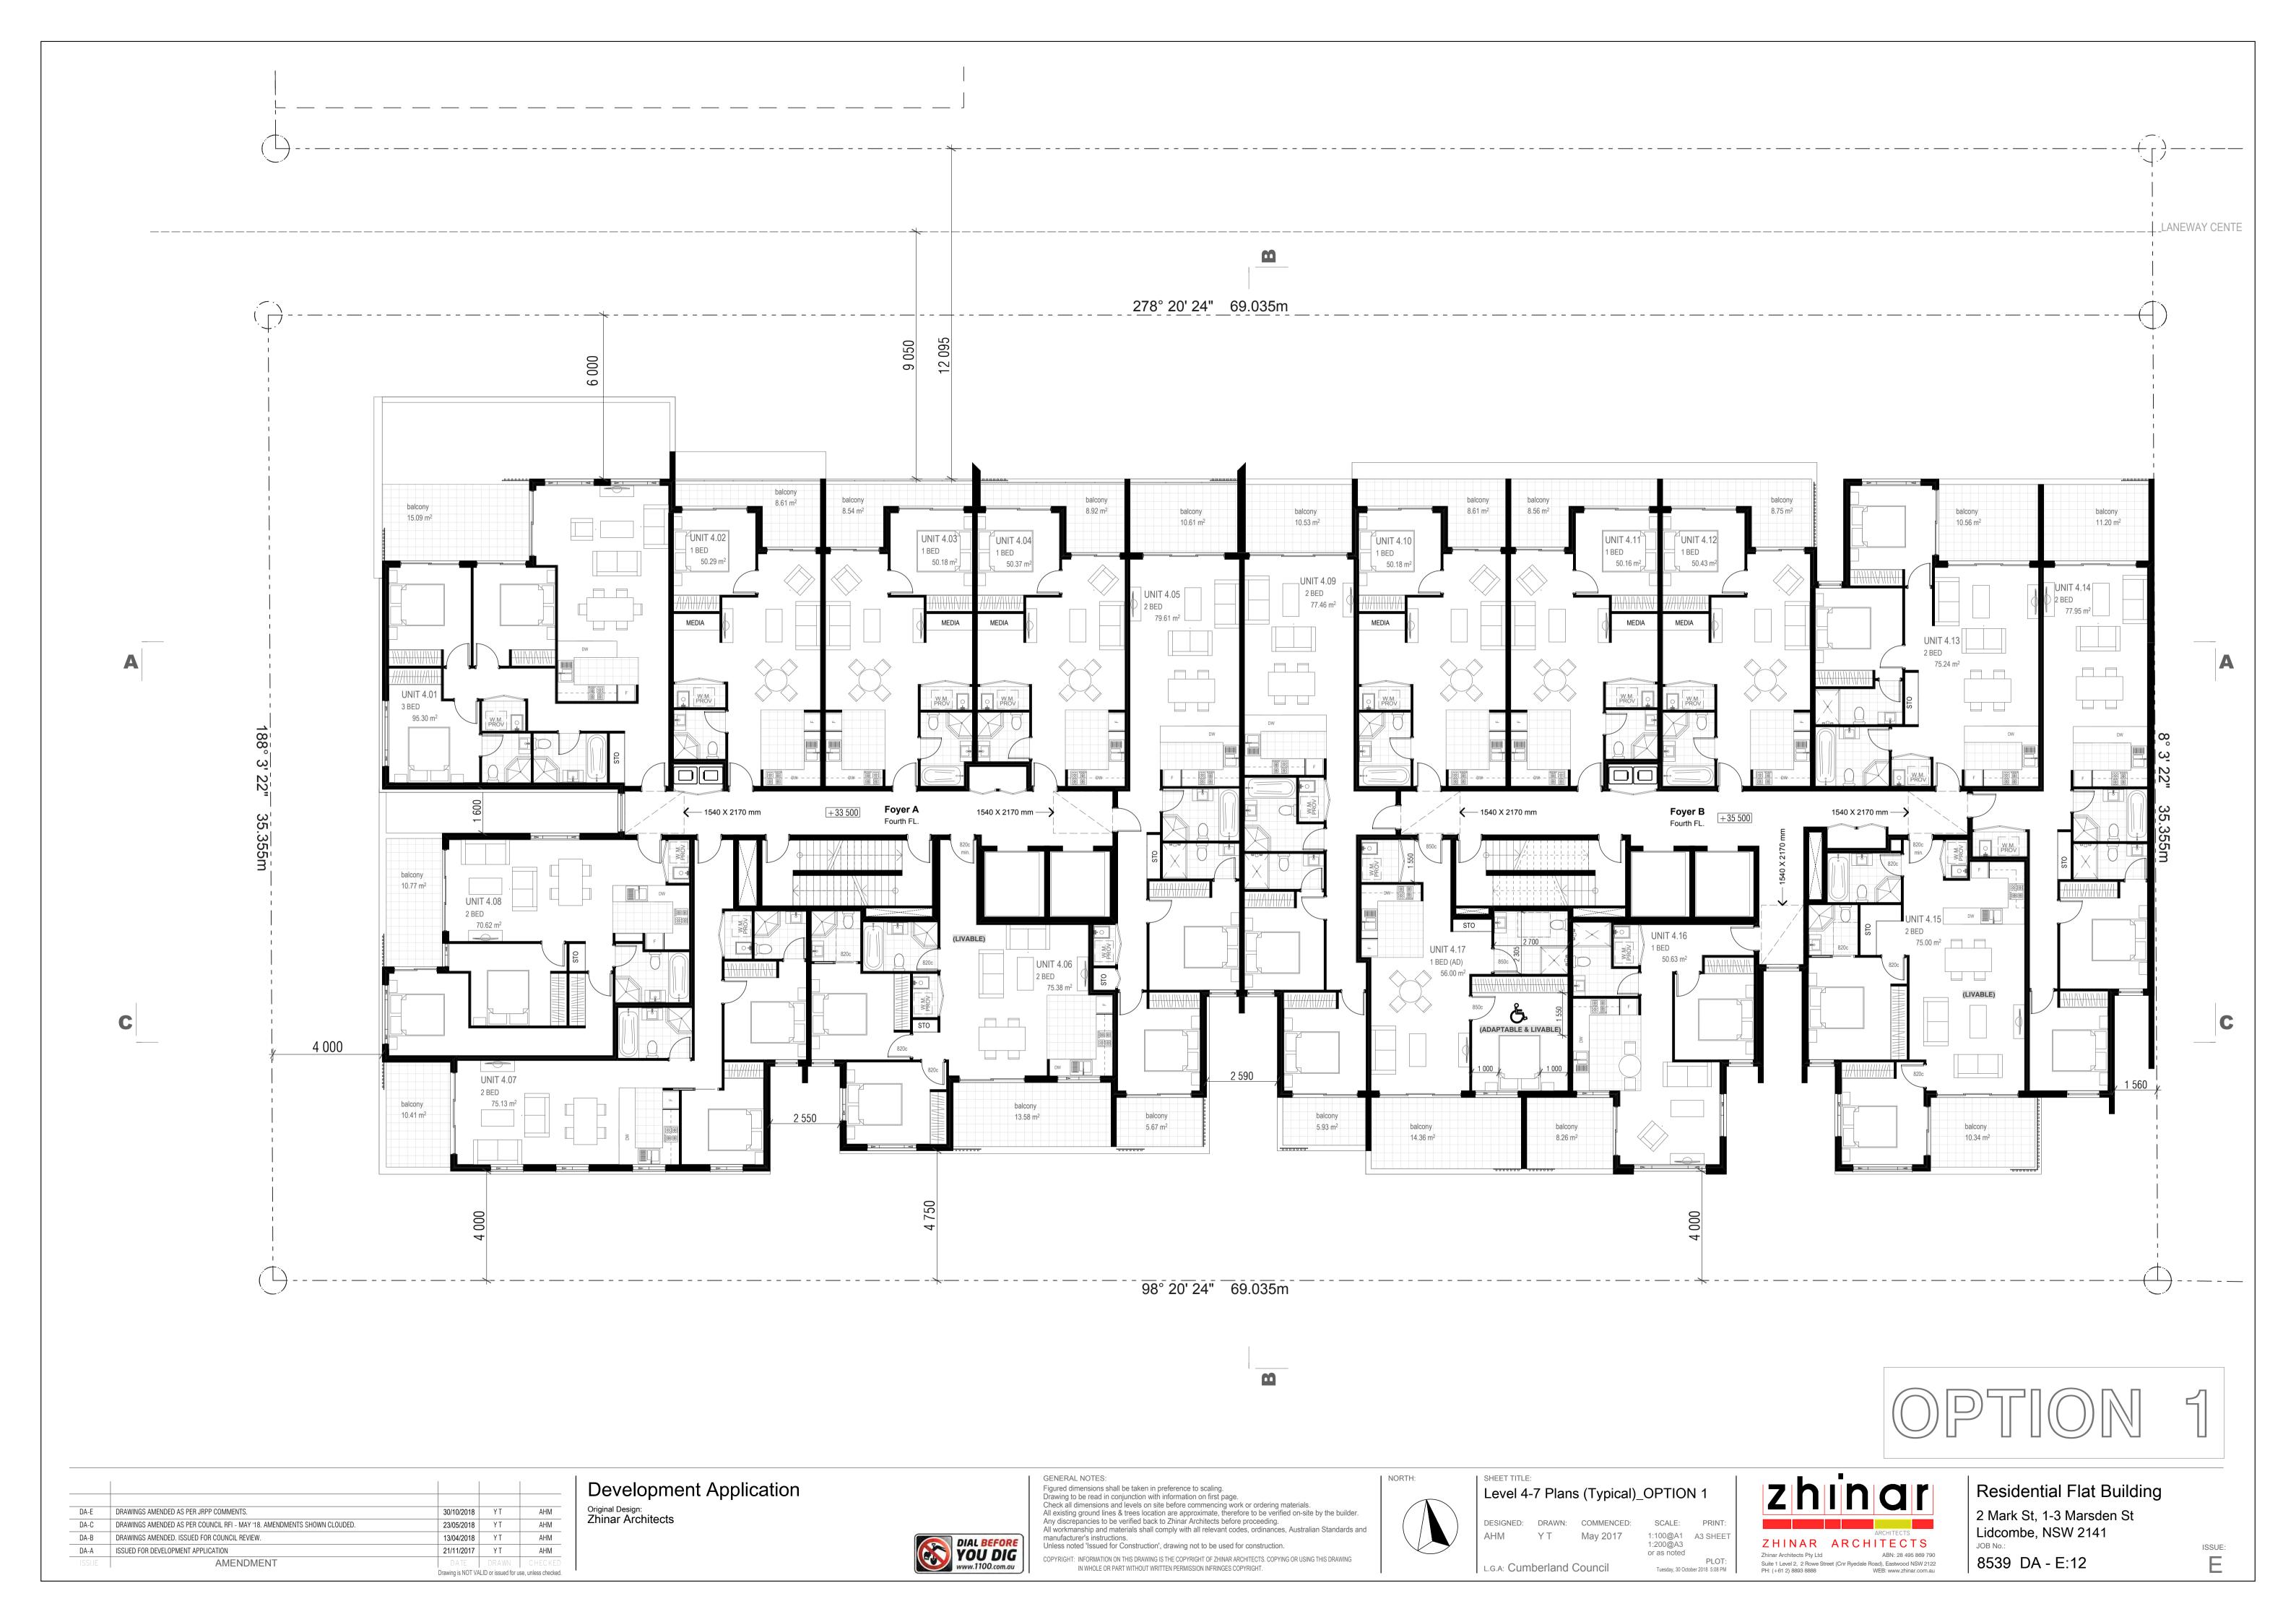


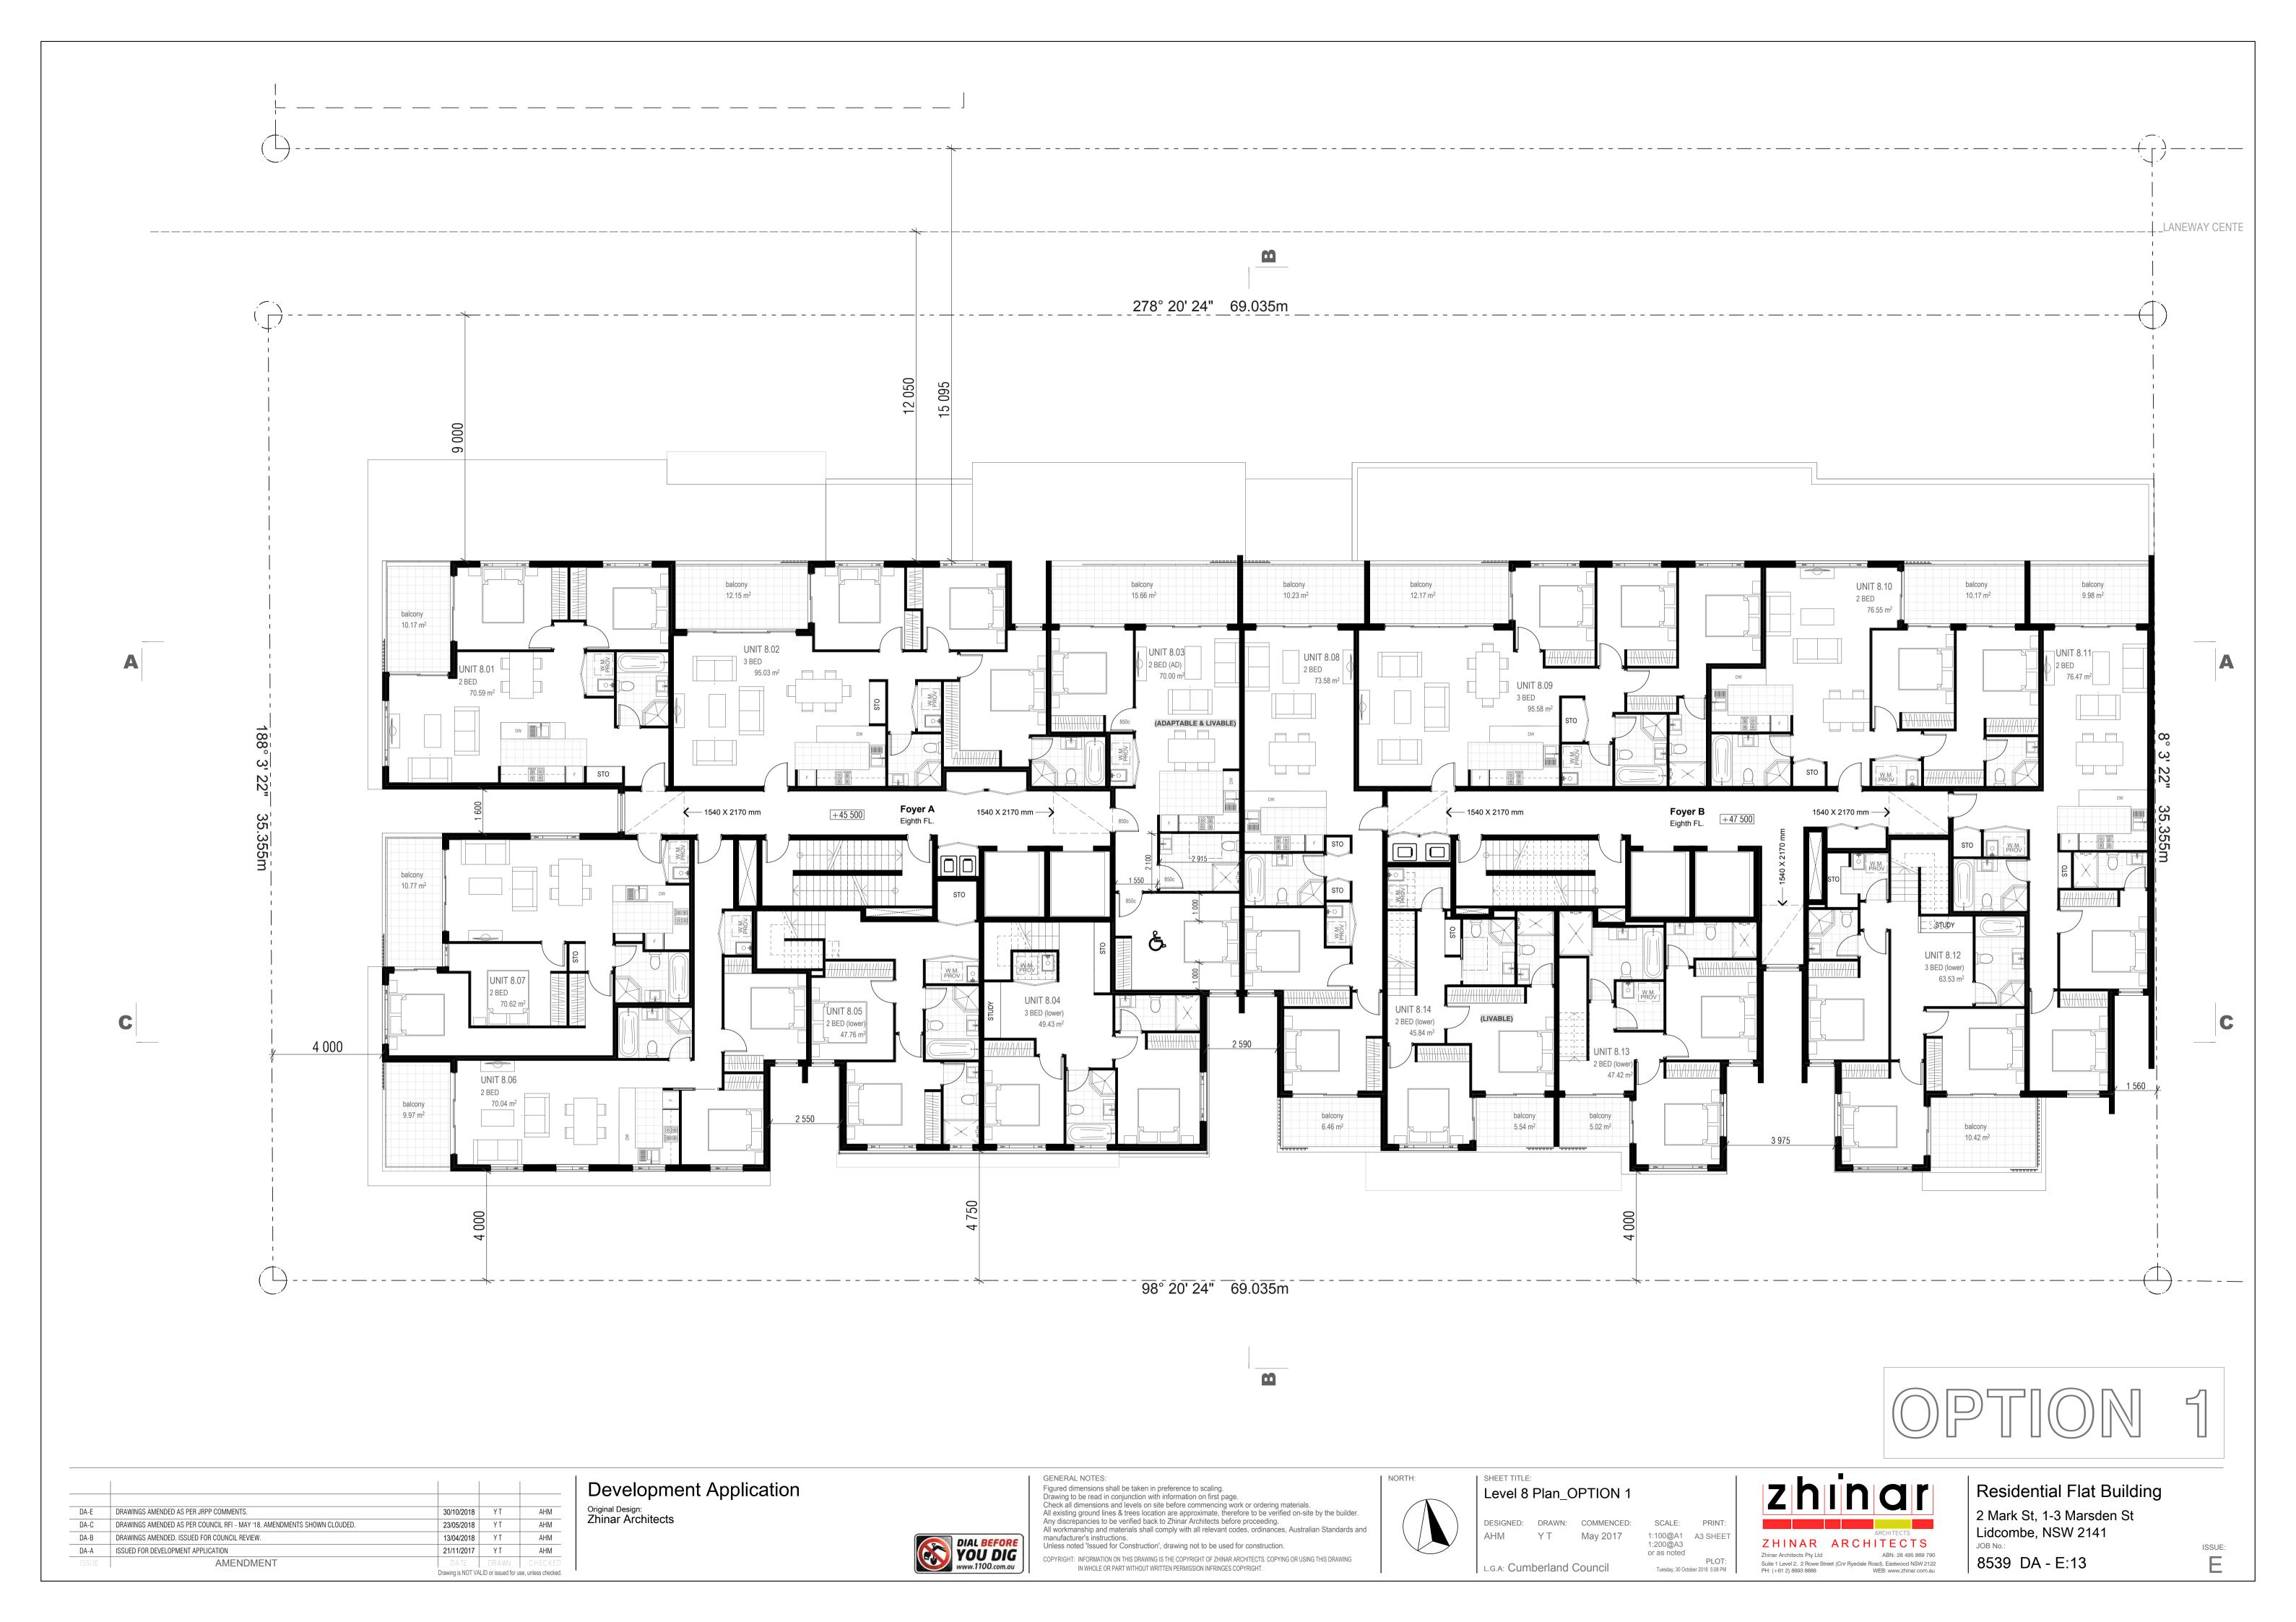

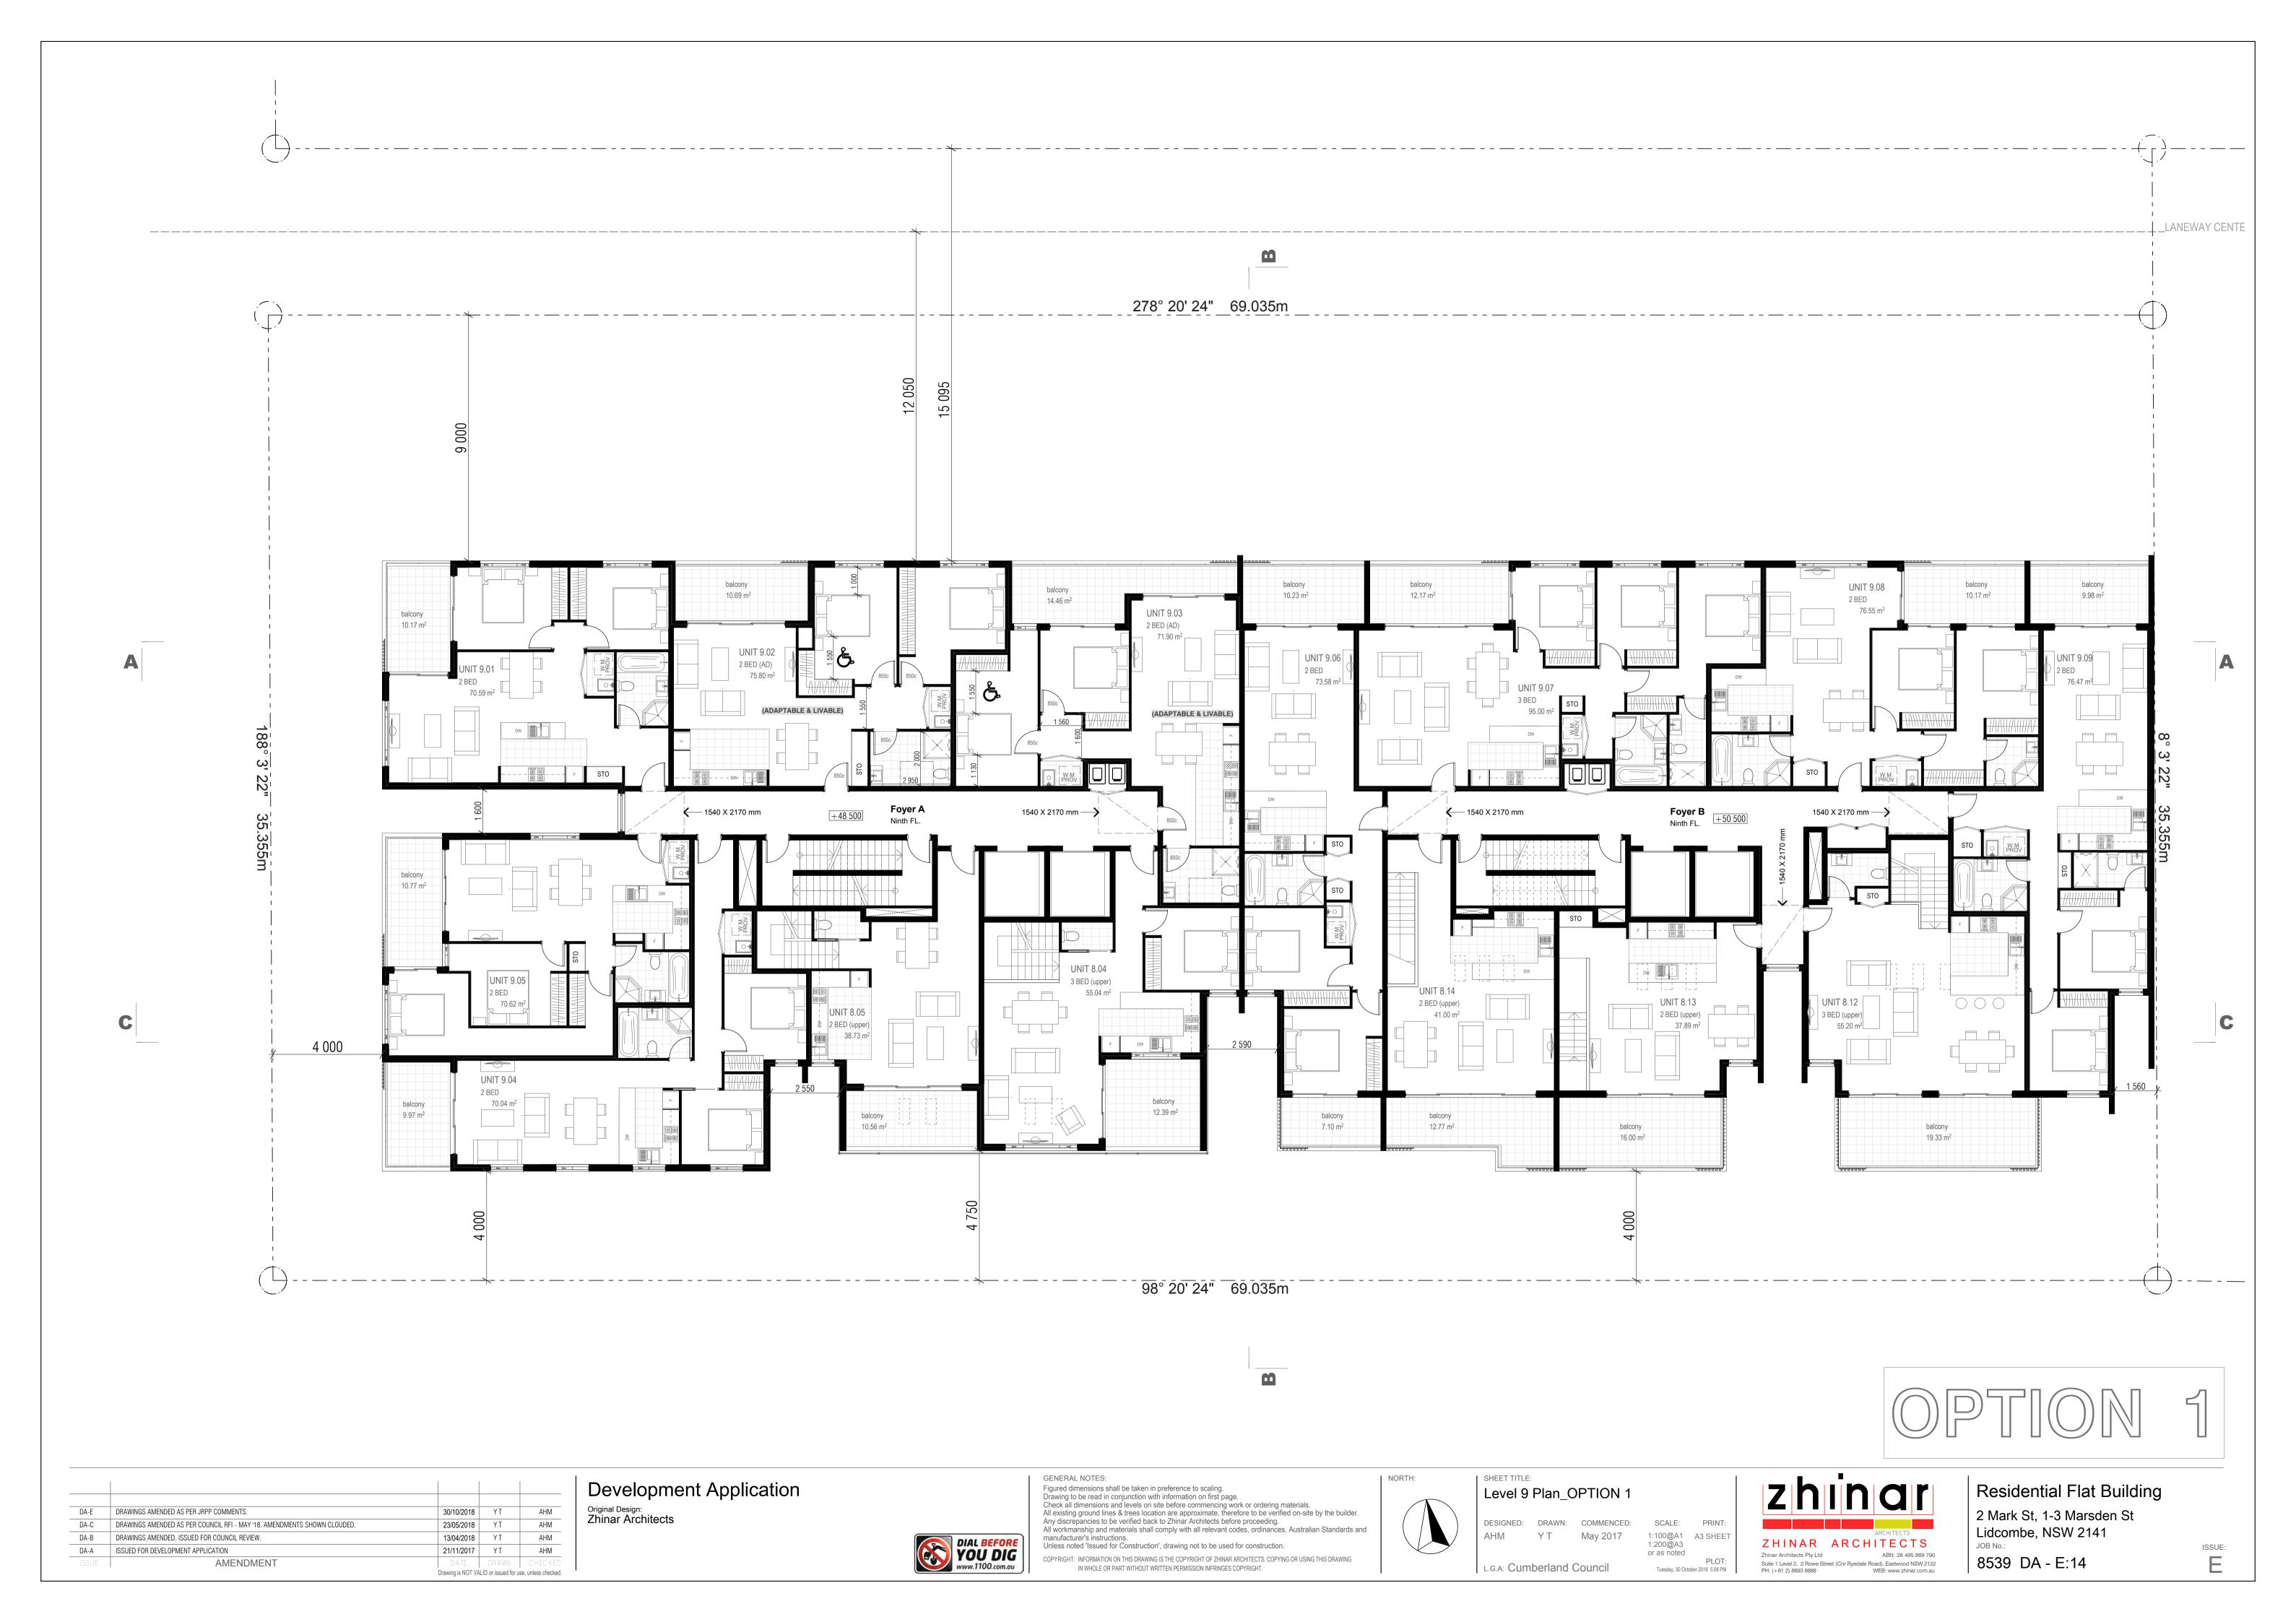

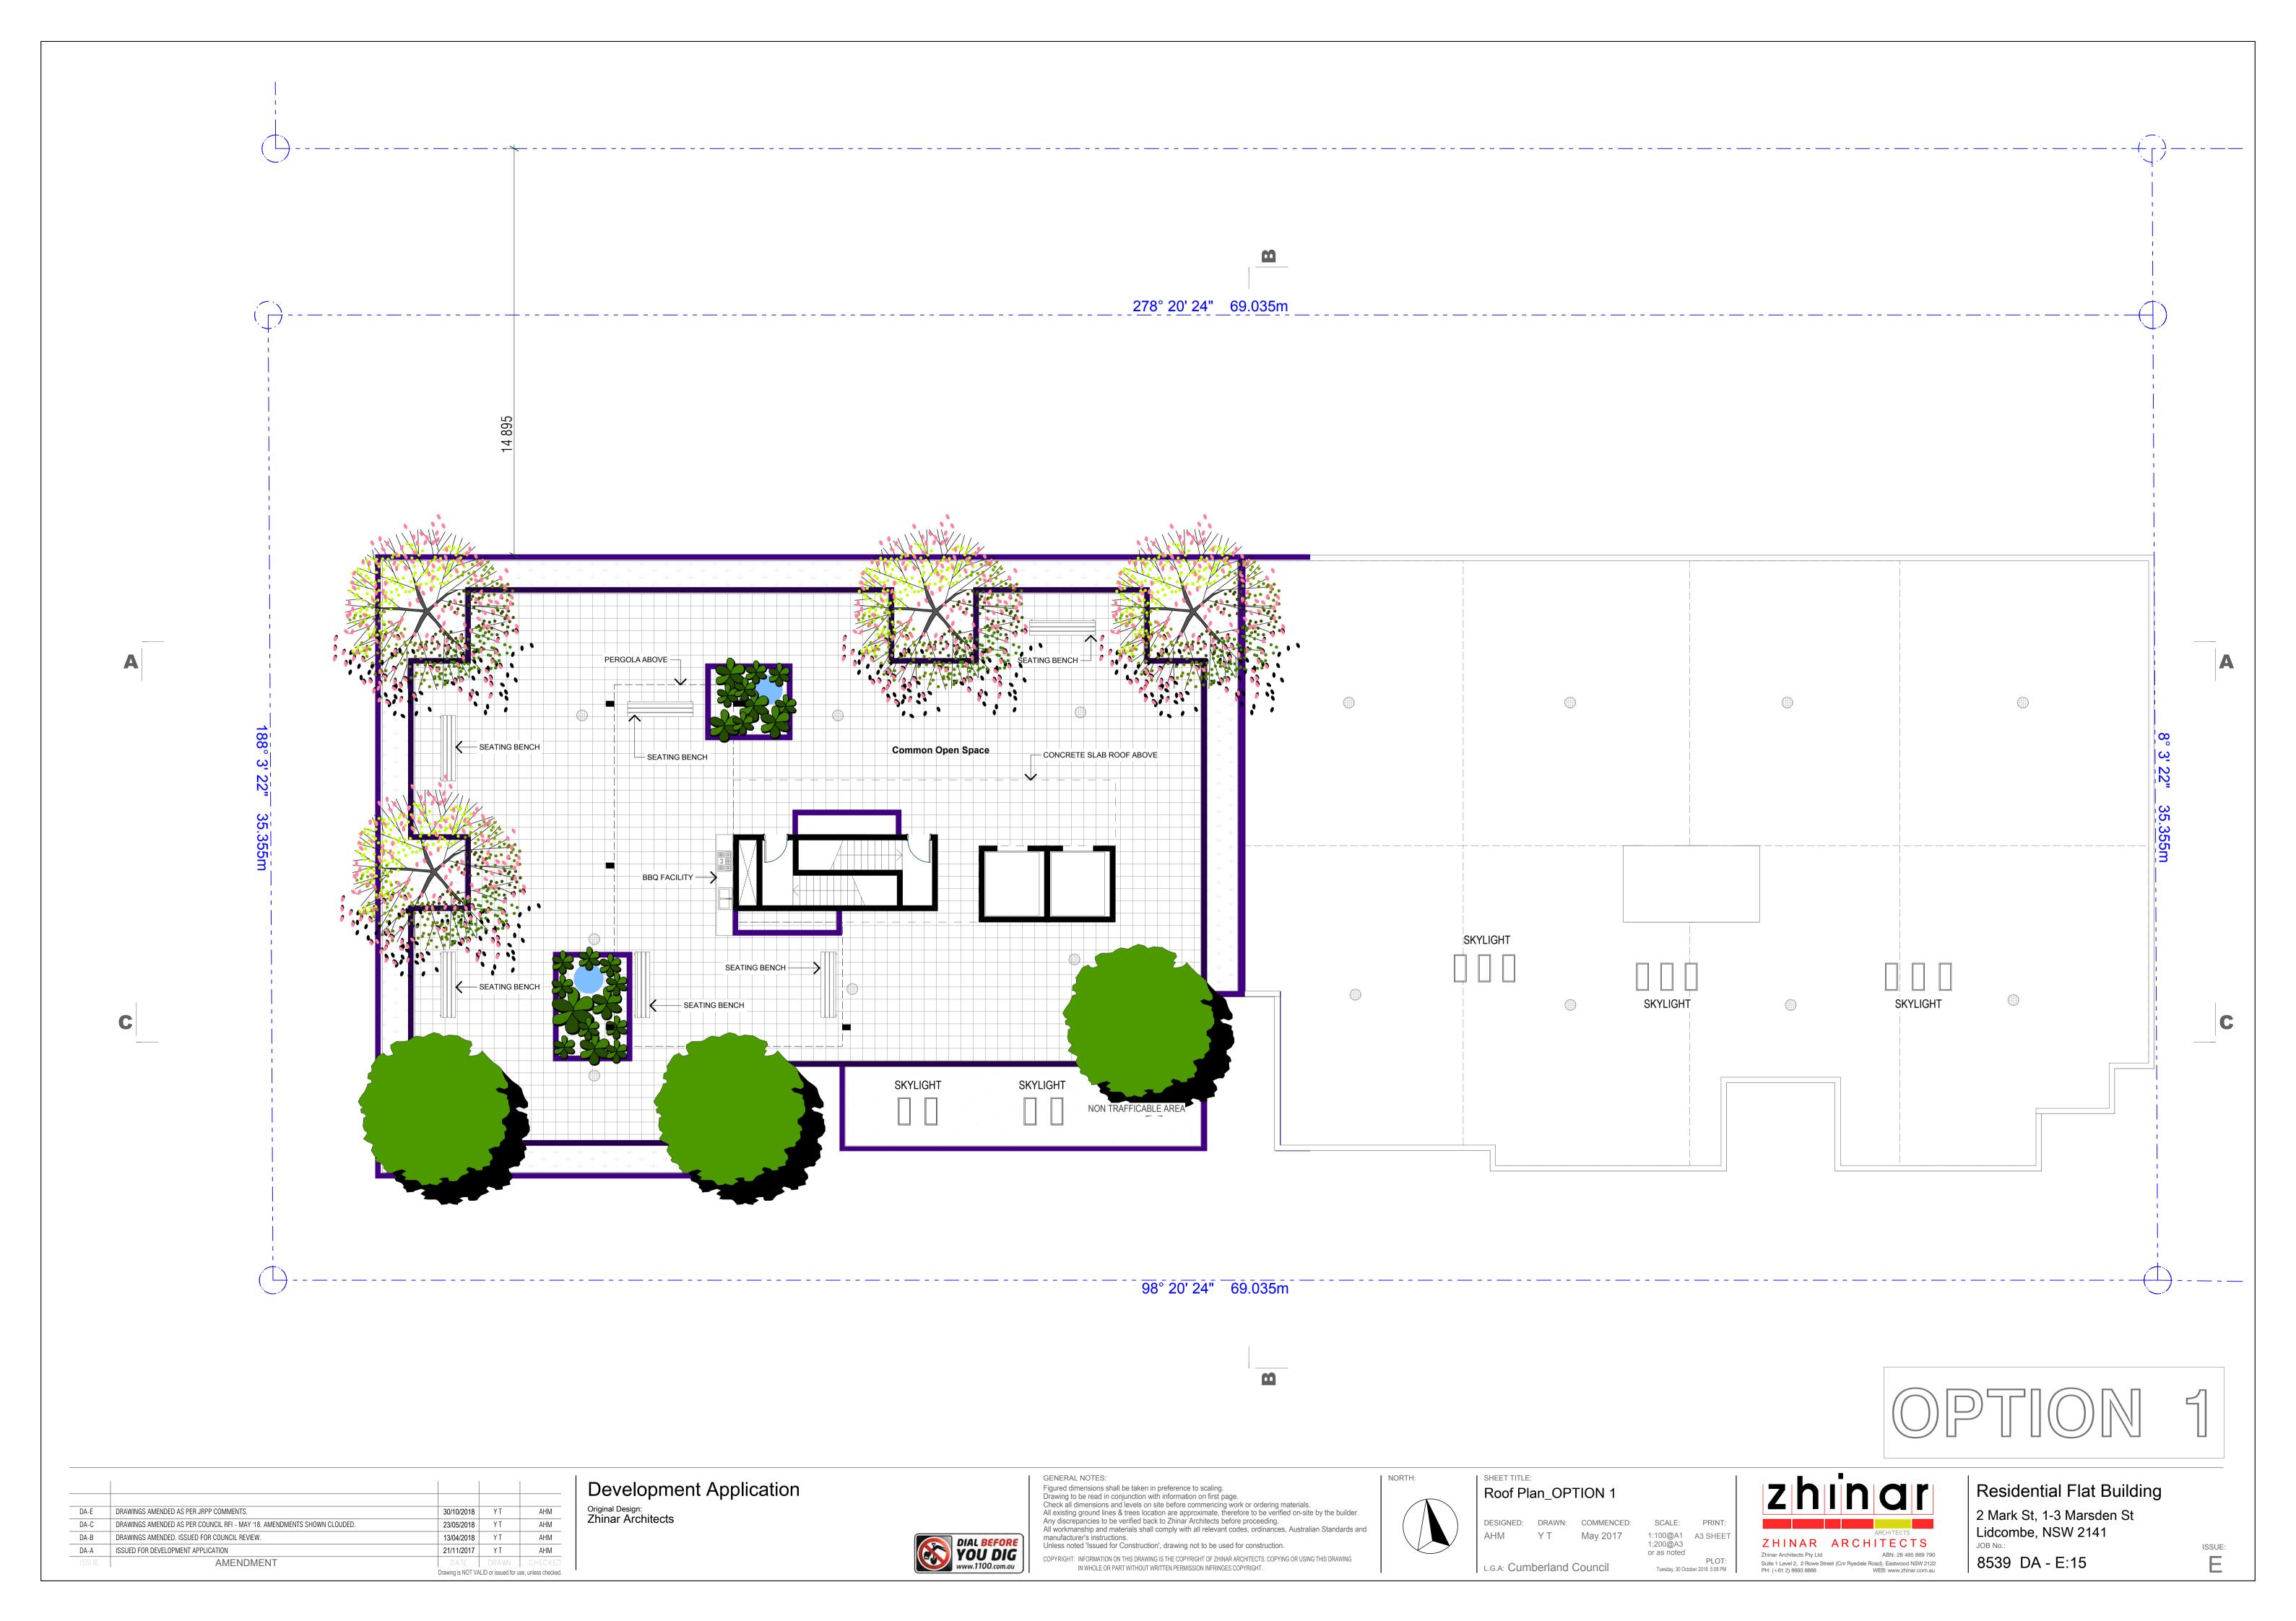



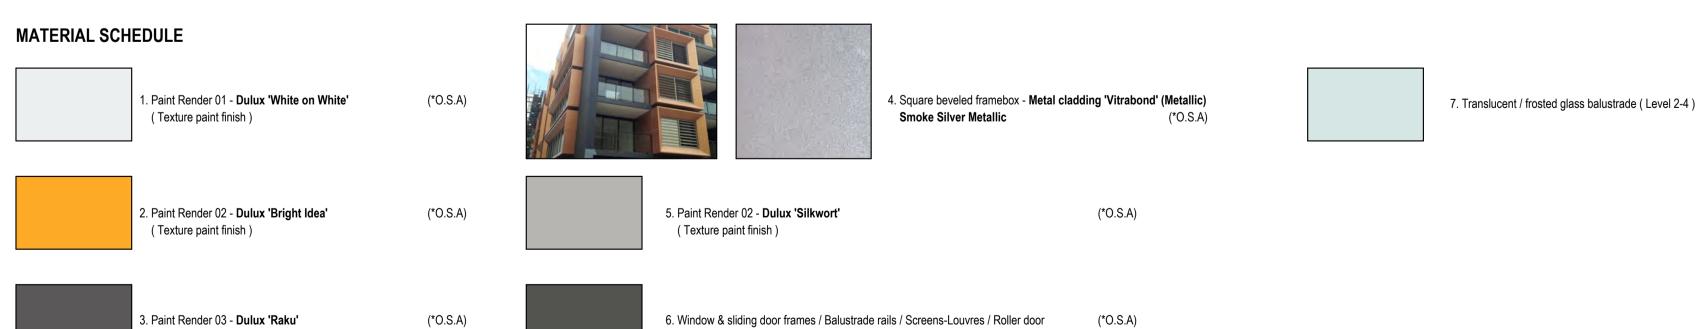



		I	I	I
DA-E	DRAWINGS AMENDED AS PER JRPP COMMENTS.	30/10/2018	ΥT	AHM
DA-C	DRAWINGS AMENDED AS PER COUNCIL RFI - MAY '18. AMENDMENTS SHOWN CLOUDED.	23/05/2018	ΥT	AHM
DA-B	DRAWINGS AMENDED. ISSUED FOR COUNCIL REVIEW.	13/04/2018	ΥT	AHM
DA-A	ISSUED FOR DEVELOPMENT APPLICATION	21/11/2017	ΥT	AHM
ISSUE	AMENDMENT	DATE	DRAWN	CHECKED
		Drawing is NOT VA	ALID or issued for u	se, unless checked.

(Texture paint finish)

Development Application

Original Design: Zhinar Architects

Colorbond 'Woodland Grey'



GENERAL NOTES:

Figured dimensions shall be taken in preference to scaling.

Drawing to be read in conjunction with information on first page.

Check all dimensions and levels on site before commencing work or ordering materials.

All existing ground lines & trees location are approximate, therefore to be verified on-site by the builder.

Any discrepancies to be verified back to Zhinar Architects before proceeding.

All workmanship and materials shall comply with all relevant codes, ordinances, Australian Standards and manufacturer's instructions.

Unless noted 'Issued for Construction', drawing not to be used for construction.

COPYRIGHT: INFORMATION ON THIS DRAWING IS THE COPYRIGHT OF ZHINAR ARCHITECTS. COPYING OR USING THIS DRAWING
IN WHOLE OR PART WITHOUT WRITTEN PERMISSION INFRINGES COPYRIGHT.

SHEET TITLE:
South Elevation_OPTION 1

L.G.A: Cumberland Council

(*O.S.A)

NORTH:

DESIGNED: DRAWN: COMMENCED: SCALE: PRINT:

AHM Y T May 2017 1:100@A1 A3 SHEET 1:200@A3 or as noted

Tuesday, 30 October 2018 5:08 PM

ARCHITECTS

ZHINAR ARCHITECTS


Zhinar Architects Pty Ltd
ABN: 28 495 869 790

Suite 1 Level 2, 2 Rowe Street (Cnr Ryedale Road), Eastwood NSW 2122
PH: (+61 2) 8893 8888
WEB: www.zhinar.com.au

Residential Flat Building
2 Mark St, 1-3 Marsden St

Lidcombe, NSW 2141 JOB No.: 8539 DA - E:17



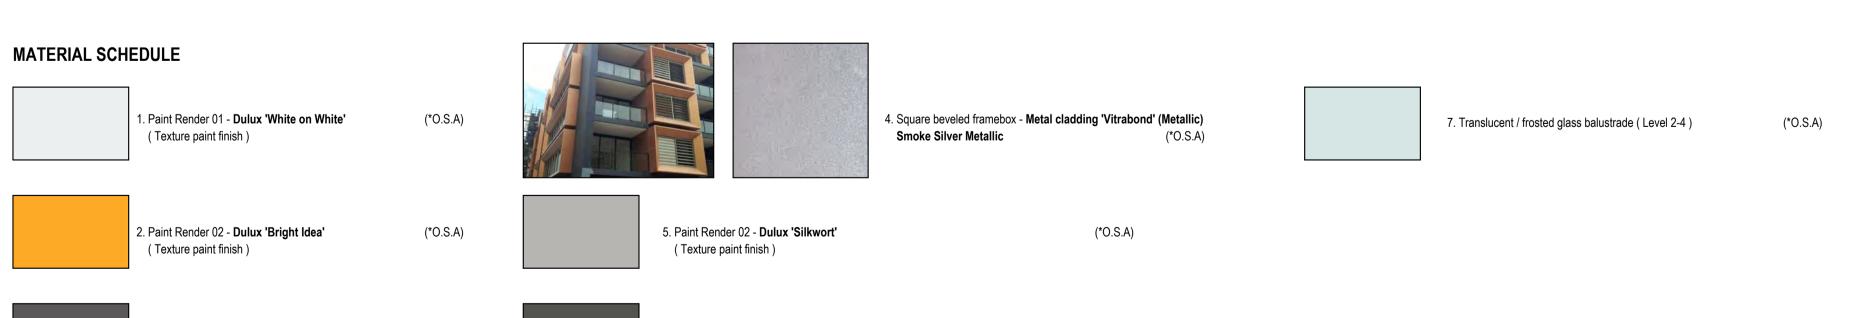



DA-E	DRAWINGS AMENDED AS PER JRPP COMMENTS.	30/10/2018	ΥT	AHM
DA-C	DRAWINGS AMENDED AS PER COUNCIL RFI - MAY '18. AMENDMENTS SHOWN CLOUDED.	23/05/2018	ΥT	AHM
DA-B	DRAWINGS AMENDED. ISSUED FOR COUNCIL REVIEW.	13/04/2018	ΥT	AHM
DA-A	ISSUED FOR DEVELOPMENT APPLICATION	21/11/2017	ΥT	AHM
ISSUE	AMENDMENT	DATE	DRAWN	CHECKED
		Drawing is NOT VA	ALID or issued for u	ise, unless checked.

(*O.S.A)

3. Paint Render 03 - **Dulux 'Raku'**

(Texture paint finish)

Development Application

6. Window & sliding door frames / Balustrade rails / Screens-Louvres / Roller door

Original Design:
Zhinar Architects

Colorbond 'Woodland Grey'



(*O.S.A)

GENERAL NOTES: Figured dimensions shall be taken in preference to scaling.

Drawing to be read in conjunction with information on first page.

Check all dimensions and levels on site before commencing work or ordering materials.

All existing ground lines & trees location are approximate, therefore to be verified on-site by the builder.

Any discrepancies to be verified back to Zhinar Architects before proceeding.

All workmanship and materials shall comply with all relevant codes, ordinances, Australian Standards and manufacturer's instructions.

Unless noted 'Issued for Construction', drawing not to be used for construction. COPYRIGHT: INFORMATION ON THIS DRAWING IS THE COPYRIGHT OF ZHINAR ARCHITECTS. COPYING OR USING THIS DRAWING IN WHOLE OR PART WITHOUT WRITTEN PERMISSION INFRINGES COPYRIGHT.

L.G.A: Cumberland Council

NORTH:

North Elevation - Marsden St_OPTION 1

DESIGNED: DRAWN: COMMENCED: SCALE: PRINT: 1:100@A1 A3 SHEET 1:200@A3 or as noted AHM Y T May 2017

Tuesday, 30 October 2018 5:08 PM

ZHINAR ARCHITECTS Zhinar Architects Pty Ltd ABN: 28 495 869 790 Suite 1 Level 2, 2 Rowe Street (Cnr Ryedale Road), Eastwood NSW 2122 PH: (+61 2) 8893 8888 WEB: www.zhinar.com.au

Residential Flat Building 2 Mark St, 1-3 Marsden St

8539 DA - E:18

Lidcombe, NSW 2141





DA-E	DRAWINGS AMENDED AS PER JRPP COMMENTS.	30/10/2018	ΥT	AHM
DA-C	DRAWINGS AMENDED AS PER COUNCIL RFI - MAY '18. AMENDMENTS SHOWN CLOUDED.	23/05/2018	ΥT	AHM
DA-B	DRAWINGS AMENDED. ISSUED FOR COUNCIL REVIEW.	13/04/2018	ΥT	AHM
DA-A	ISSUED FOR DEVELOPMENT APPLICATION	21/11/2017	ΥT	AHM
ISSUE	AMENDMENT	DATE	DRAWN	CHECKED
		Drawing is NOT VA	ALID or issued for u	se, unless checked.

Development Application Original Design:
Zhinar Architects



GENERAL NOTES: Figured dimensions shall be taken in preference to scaling.

Drawing to be read in conjunction with information on first page.

Check all dimensions and levels on site before commencing work or ordering materials.

All existing ground lines & trees location are approximate, therefore to be verified on-site by the builder.

Any discrepancies to be verified back to Zhinar Architects before proceeding.

All workmanship and materials shall comply with all relevant codes, ordinances, Australian Standards and manufacturer's instructions.

Unless noted 'Issued for Construction', drawing not to be used for construction. COPYRIGHT: INFORMATION ON THIS DRAWING IS THE COPYRIGHT OF ZHINAR ARCHITECTS. COPYING OR USING THIS DRAWING IN WHOLE OR PART WITHOUT WRITTEN PERMISSION INFRINGES COPYRIGHT.

West El	evation	ı - Mark St_	OPTION	J 1
DESIGNED:	DRAWN.	COMMENCED.	SCALE:	PRINT:


L.G.A: Cumberland Council

NORTH:

AHM Y T May 2017 1:100@A1 A3 SHEET 1:200@A3 or as noted ZHINAR ARCHITECTS Zhinar Architects Pty Ltd ABN: 28 495 869 790 Suite 1 Level 2, 2 Rowe Street (Cnr Ryedale Road), Eastwood NSW 2122 PH: (+61 2) 8893 8888 WEB: www.zhinar.com.au Tuesday, 30 October 2018 5:08 PM

Residential Flat Building 2 Mark St, 1-3 Marsden St Lidcombe, NSW 2141

8539 DA - E:19

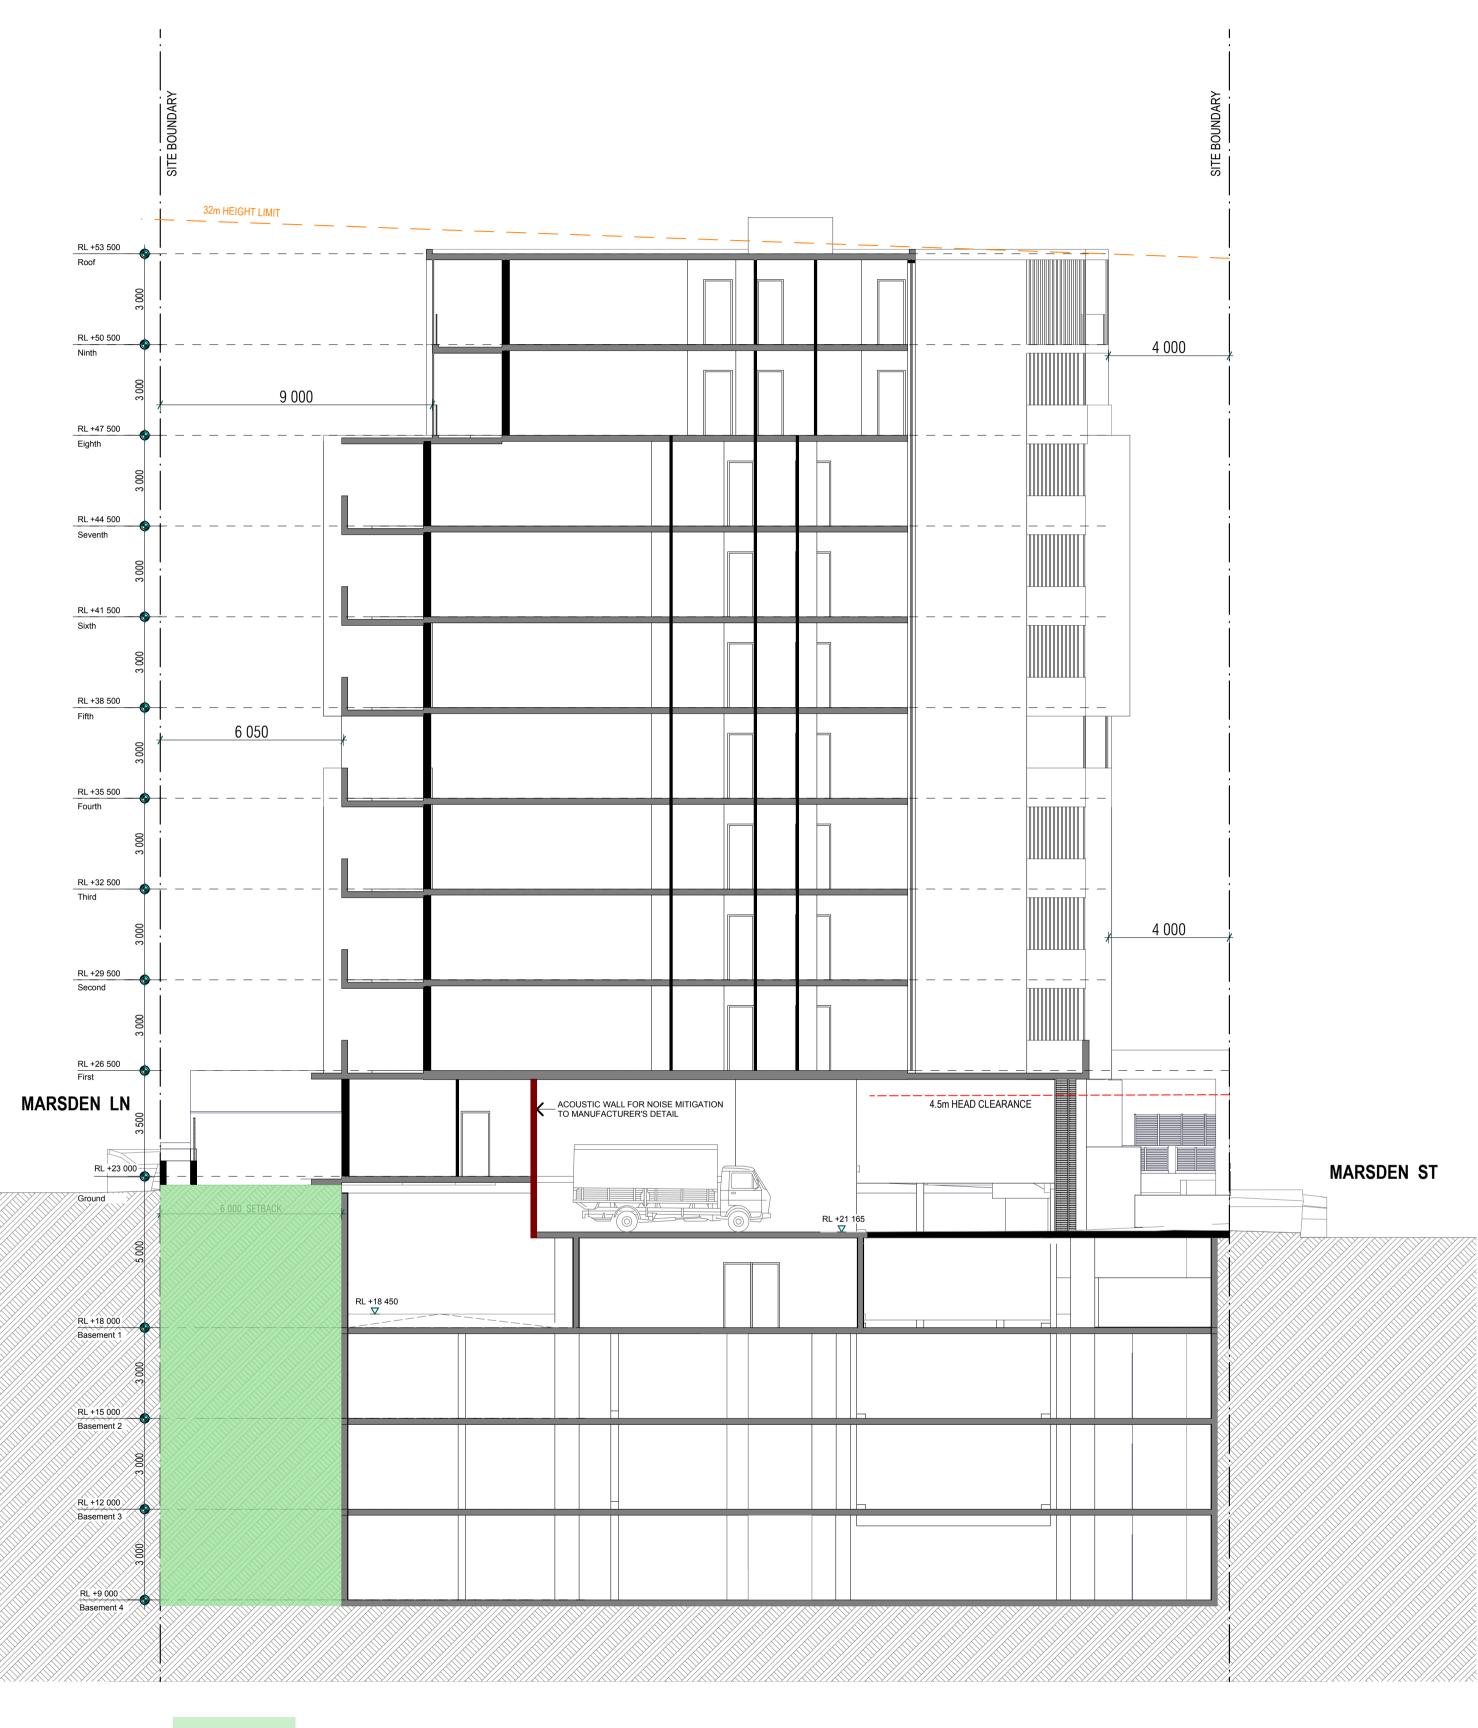

DEEP SOIL AREA

OPTION 1

DA-E DRAWINGS AMENDED AS PER JRPP COMMENTS.

DA-C DRAWINGS AMENDED AS PER COUNCIL RFI - MAY '18. AMENDMENTS SHOWN CLOUDED.

DA-B DRAWINGS AMENDED. ISSUED FOR COUNCIL REVIEW.

DA-A ISSUED FOR DEVELOPMENT APPLICATION

ISSUE

AMENDMENT

DATE DRAWN CHECKED Drawing is NOT VALID or issued for use, unless checked.

Development Application
Original Design:
Zhinar Architects



GENERAL NOTES:

Figured dimensions shall be taken in preference to scaling.

Drawing to be read in conjunction with information on first page.

Check all dimensions and levels on site before commencing work or ordering materials.

All existing ground lines & trees location are approximate, therefore to be verified on-site by the builder.

Any discrepancies to be verified back to Zhinar Architects before proceeding.

All workmanship and materials shall comply with all relevant codes, ordinances, Australian Standards and manufacturer's instructions.

Unless noted 'Issued for Construction', drawing not to be used for construction.

COPYRIGHT: INFORMATION ON THIS DRAWING IS THE COPYRIGHT OF ZHINAR ARCHITECTS. COPYING OR USING THIS DRAWING IN WHOLE OR PART WITHOUT WRITTEN PERMISSION INFRINGES COPYRIGHT.

SHEET TITLE:	
Section B	_OPTION 1

L.G.A: Cumberland Council

NORTH:

DESIGNED: DRAWN: COMMENCED: SCALE: PRINT:

AHM Y T May 2017 1:100@A1 A3 SHEET 1:200@A3 or as noted

Tuesday, 30 October 2018 5:08 PM

ARCHITECTS

ZHINAR ARCHITECTS

Zhinar Architects Pty Ltd
ABN: 28 495 869 790

Suite 1 Level 2, 2 Rowe Street (Cnr Ryedale Road), Eastwood NSW 2122
PH: (+61 2) 8893 8888
WEB: www.zhinar.com.au


Residential Flat Building
2 Mark St, 1-3 Marsden St
Lidcombe, NSW 2141


8539 DA - E:22

IMPACT OF PROPOSED BUILDING TO RECENTLY APPROVED 4-14 MARK ST





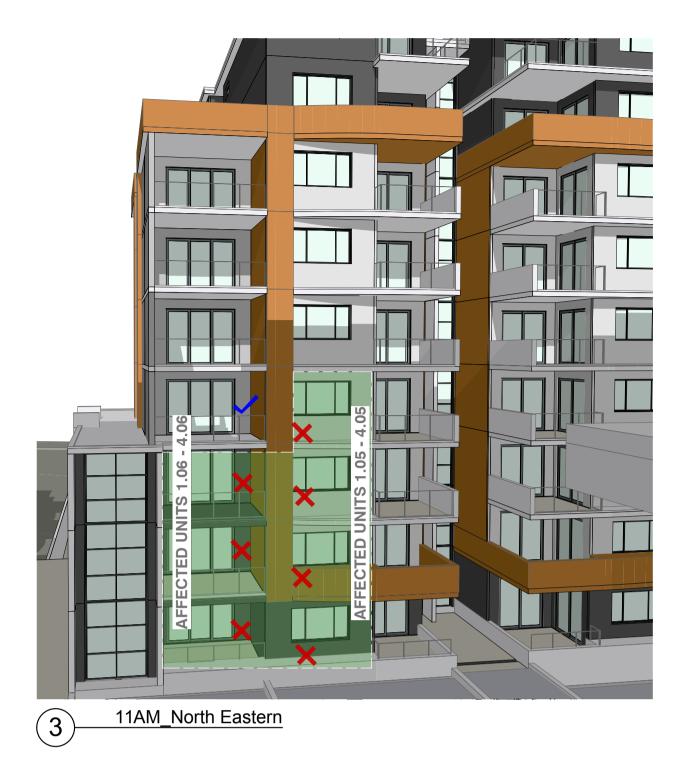

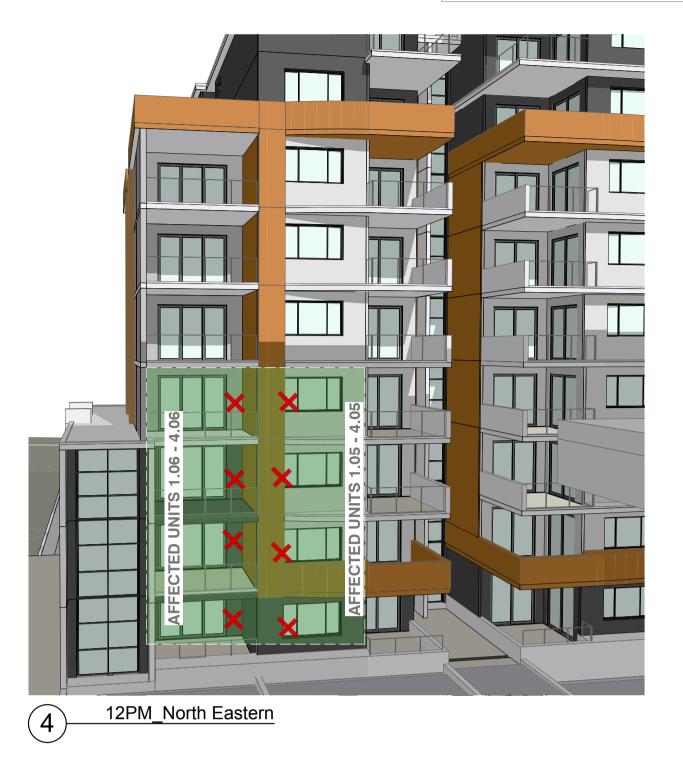



1PM_North Eastern

Units that receive solar during winter solstice

Units that do not receive solar during winter solstice



2PM_North Eastern



NORTH:

3PM_North Eastern

SHADOW IMPACT TO 4-14 MARK ST:

Total number of residential units at 4-14 Mark St = 165 units

Number of units receiving nil / less than 2 hours solar during winter solstice due to solar impact of the proposal =

- 8 North-facing units (highlighted in green)

- 9 East-facing units

Total 17 units will be affected by the shadow from the proposal = 10.3%

UNIT NUMBER & TYPE	UNIT TYPE	SOLAR ACCESS	TOTAL HOURS	SOLAR COMPLIANCE
Unit 1.01 – 9.01 (typical)	2BR	13:00-15:00	2	YES
Unit 1.02 – 9.02 (typical)	1BR	13:00-15:00	2	YES
Unit 1.03 – 9.03 (typical)	2BR	09:00-15:00	6	YES
Unit 1.04 – 9.04 (typical)	2BR	09:00-15:00	6	YES
Unit 1.05 – 4.05 (typical)	2BR	09:00-15:00	6	YES
Unit 5.05 – 9.05 (typical)	2BR	09:00-15:00	6	YES
Unit 1.06 – 3.06 (typical)	3BR	09:00-14:00	5	YES
Unit 4.06	1BR	09:00-14:00	5	YES
Unit 5.06 – 7.06 (typical)	1BR	09:00-14:00	5	YES
Unit 8.06 – 9.06 (typical)	3BR	09:00-11:30	2.5	YES
Unit 1.07 – 7.07 (typical)	2BR		0	NO
Unit 8.07 – 9.07 (typical)	3BR	09:00-11:30	2.5	YES
Unit 1.08 – 7.08 (typical)	1BR (AD)		0	NO
Unit 8.08 – 9.08 (typical)	2BR	13:00-15:00	2	YES
Unit 1.09 – 7.09 (typical)	2BR	09:00-10:00	1	NO
Unit 8.09 – 9.09 (typical)	2BR	13:00-15:00	2	YES
Unit 1.10 – 7.10 (typical)	2BR	13:00-15:00	2	YES
Unit 8.10 – 9.10 (typical)	2BR	13:00-15:00	2	YES
Unit 1.11 – 7.11 (typical)	2BR	13:00-15:00	2	YES
Unit 8.11 – 9.11 (typical)	2BR	14:00-15:00	1	NO
Unit 1.12 – 7.12 (typical)	2BR	13:00-15:00	2	YES
Unit 8.12 – 9.12 (typical)	3BR	09:00-10:00	1	NO
Unit 1.13 – 7.13 (typical)	2BR	14:00-15:00	1	NO
Unit 8.13 – 9.13 (typical)	3BR	09:00-11:00	2	YES
Unit 1.14 – 7.14 (typical)	2BR	09:00-10:00	1	NO
Unit 8.14 – 9.14 (typical)	2BR	13:00-15:00	2	YES
Unit 1.15 – 7.15 (typical)	1BR (1AD)	09:00-11:00	2	YES
Unit 8.15 – 9.15 (typical)	1BR		0	NO
Unit 1.16 – 7.16 (typical)	2BR	09:00-11:00	2	YES
Unit 8.16 – 9.16 (typical)	2BR	13:00-15:00	2	YES
Unit 1.17 – 7.17 (typical)	2BR	13:00-15:00	2	YES
Unit 1.18 – 7.18 (typical)	1BR		0	NO
Unit 1.19 – 7.19 (typical)	2BR	13:00-15:00	2	YES

SOLAR ACCESS	TOTAL HOURS	SOLAR COMPLIANCE
13:00-15:00	2	YES
13:00-15:00	2	YES
09:00-15:00	6	YES
09:00-15:00	6	YES
	0	NO
09:00-15:00	6	YES
	0	NO
	0	NO
09:00-14:00	5	YES
09:00-11:30	2.5	YES
	0	NO
	0	NO
	0	NO
13:00-15:00	2	YES
	0	NO
13:00-15:00	2	YES
14:00-15:00	1	NO
13:00-15:00	2	YES
09:00-10:00	1	NO
14:00-15:00	1	NO
09:00-11:00	2	YES
09:00-10:00	1	NO
13:00-15:00	2	YES
09:00-11:00	2	YES
	0	NO
09:00-11:00	2	YES
13:00-15:00	2	YES
13:00-15:00	2	YES
	0	NO
13:00-15:00	2	YES

DA-E	DRAWINGS AMENDED AS PER JRPP COMMENTS.	30/10/2018	ΥT	AHM
DA-C	DRAWINGS AMENDED AS PER COUNCIL RFI - MAY '18. AMENDMENTS SHOWN CLOUDED.	23/05/2018	ΥT	AHM
DA-B	DRAWINGS AMENDED. ISSUED FOR COUNCIL REVIEW.	13/04/2018	ΥT	AHM
DA-A	ISSUED FOR DEVELOPMENT APPLICATION	21/11/2017	ΥT	AHM
ISSUE	AMENDMENT	DATE	DRAWN	CHECKED

Drawing is NOT VALID or issued for use, unless checked.

Development Application Original Design: Zhinar Architects



GENERAL NOTES: Figured dimensions shall be taken in preference to scaling. Drawing to be read in conjunction with information on first page. Check all dimensions and levels on site before commencing work or ordering materials.

All existing ground lines & trees location are approximate, therefore to be verified on-site by the builder.

Any discrepancies to be verified back to Zhinar Architects before proceeding.

All workmanship and materials shall comply with all relevant codes, ordinances, Australian Standards and

manufacturer's instructions.

COPYRIGHT: INFORMATION ON THIS DRAWING IS THE COPYRIGHT OF ZHINAR ARCHITECTS. COPYING OR USING THIS DRAWING IN WHOLE OR PART WITHOUT WRITTEN PERMISSION INFRINGES COPYRIGHT.

Shadow Impact to 4-14 Mark St (Winter Solstice)_OPTION 1

DESIGNED: DRAWN: COMMENCED: SCALE: PRINT: 1:100@A1 A3 SHEET 1:200@A3 or as noted AHM YT May 2017 L.G.A: Cumberland Council

Tuesday, 30 October 2018 5:08 PM

ZHINAR ARCHITECTS ABN: 28 495 869 790 Zhinar Architects Pty Ltd Suite 1 Level 2, 2 Rowe Street (Cnr Ryedale Road), Eastwood NSW 2122 PH: (+61 2) 8893 8888 WEB: www.zhinar.com.au

117 / 165 UNITS – 70.9% (min. 70%)

Residential Flat Building 2 Mark St, 1-3 Marsden St

Lidcombe, NSW 2141